

AutoZone Store Development Plan Submission

AutoZone Store No. 6486 3913 Oleander Drive

Wilmington, NC New Hanover County

Architect:

AutoZone Development, LLC c/o: George Callow 123 S. Front Street, 3rd Floor Memphis, Tennessee 38103 (901) 495 - 8705

> Plan Submittal Date: September 29, 2015

construction to insure that no clearing, grading or staging of materials will occur in those areas.

4. All pavement markings in public rights-of-way and for driveways are to be thermoplastic and meet City and/or

5. Once streets are open to traffic, contact Traffic Engineering regarding the installation of traffic and street name signs. Proposed street names must be approved prior to installation of street name signs.

7. Contact Traffic Engineering at 910-341-7888 to ensure that all traffic signal facilities and equipment are shown on

- 10. All parking stall markings and lane arrows within the parking areas shall be white.

- 14. A utility cut permit is required for each open cut of a city street.
- 15. Any broken or missing sidewalk panels will be replaced
- 16. Contact Karen Dixon at 910-341-7888 to discuss street lighting options.
- 17. Water and sewer service shall meet Cape Fear Public Utility Authority (CFPUA) details and specifications.
- 18, Project shall comply with CFPUA Cross Connection Control requirements. Water meter(s) cannot be released until all requirements are met and the State has given their final approval. Call 910-343-3910 for information 19. If the contractor desires CFPUA water for construction, he shall apply in advance for this service and must provide a reduced pressure zone (RPZ) backflow prevention device on the developer's side of the water meter box.
- 20. Any irrigation system supplied by CFPUA water shall comply with the CFPUA Cross Connection Control regulations. Call 919-343-3910 for information.
- 22. Any backflow prevention devices required by the CFPUA will need to be on the list of approved devices by USCFCCCHR
- 23. Contractor to field verify existing water and sewer service locations, sizes and materials prior to construction. Engineer to
- 24. Contractor shall maintain all-weather access for emergency vehicles at all times during construction.
- 25. Underground fire line(s) must be permitted and inspected by the Wilmington Fire Department from the public right-of-way to the building. Contact the Wilmington Fire Department Division of Fire and Life Safety at 910-341-0696. 26. No obstructions are permitted in the space between thirty (30) inches and ten (10) feet above the ground within the
- 27. Contact the North Carolina One Call Center at 1-800-632-4949 prior to doing any digging, clearing, or grading

Triangle Site Design, PLLC c/o: Matt Lowder, PE 4006 Barrett Drive, Suite 203 Raleigh, NC 27609 919-553-6570 mlowder@trianglesitedesign.com



. Prior to any clearing, grading or construction activity, tree protection fencing shall be installed around protected trees or groves of trees. No construction workers, tools, materials, or vehicles are permitted within the tree protection fencing. $2. \ \, \text{Any trees and/or areas designated to be protected must be properly barricaded with fencing and protected throughout} \\$ 3. No equipment is allowed on site until all tree protection fencing and silt fencing is installed and approved. Protective fencing is to be maintained throughout the duration of the project, and contractors shall receive adequate instruction on tree protection methods.

6. Traffic control devices (including signs and pavement markings) in areas open to public traffic are to meet MUTCD (Manual on Uniform Traffic Control Devices) standards.

- 8. Call Traffic Engineering at 910-341-7888 forty-eight (48) hours prior to any excavation in the right-of-way. 9. Traffic Engineering must approve of pavement marking prior to actual striping.
- 11. All traffic control signs and markings off the right-of-way are to be maintained by the property owner.
- 12. Stop signs and street signs to remain in place during construction.
- 13. Tactile warning mats will be installed on all wheelchair ramps.

- 21. Any irrigation system shall be equipped with a rain and freezer sensor.

Civil Engineering Plans Prepared by:

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C1.4 CONSTRUCTION DETAILS C1.5STORMWATER MANAGEMENT DETAILS

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DEMOLITION PLAN D1.0LIGHTING PLAN LP1.0

ALTA/ACSM LAND TITLE SURVEY 1 of 2

ALTA/ACSM LAND TITLE SURVEY 2 of 2



Applicant / Future Property Owner:

AutoZone Development, LLC

c/o: Wade Davis

123 S. Front Street, 3rd Floor

Memphis, Tennessee 38103

(901) 495 - 8701

wade.davis@autozone.com



EXISTING PROPERTY OWNERS:

INDEPENDENCE GENE LLC HENRY E. MILLER, JR 1713 N. LUMINA AVENUE WRIGHTSVILLE BEACH, NC 28480 910-256-2778

TRAFFIC CONTROL NOTES THE DISTRICT OFFICE OF THE NORTH CAROLINA DEPARTMENT OF TRANSPORTATION (NCDOT) MUST BE NOTIFIED AT LEAST 24 HOURS TRAFFIC MUST BE MAINTAINED AT ALL TIMES AND TRAFFIC CONTROL MUST COMPLY WITH THE MANUAL OF UNIFORM TRAFFIC CONTROL DEVICES (MUTCD) AND WITH THE CURRENT EDITION OF THE NCDOT STANDARDS AND SPECIFICATIONS ALL LANES OF TRAFFIC ARE TO BE OPEN DURING THE HOURS OF 6:00 AM TO 9:00 AM AND FROM 4:00 PM TO 6:00 PM. A MINIMUM OF ONE 12-FOOT LANE SHALL BE MAINTAINED AT ALL TIMES. ALL ROADWAY SIGNS WHICH ARE TO BE REMOVED DURING CONSTRUCTION ARE TO BE REINSTALLED AS SOON AS POSSIBLE. DURING NON-WORKING HOURS, EQUIPMENT IS TO BE PARKED AS CLOSE TO THE RIGHT OF WAY LINE AS POSSIBLE AND BE PROPERLY BARRICADED IN ORDER TO PREVENT ANY EQUIPMENT OBSTRUCTION WITHIN THE TRAVEL LANE.

ALL CONTRACTORS DOING WORK WITHIN STATE RIGHT OF WAY ARE TO HAVE A COPY OF THESE PLANS ON THE JOB SITE. WHEN PERSONNEL AND/OR EQUIPMENT ARE WITHIN 5' OF AN OPEN TRAVEL LANE, THE CONTRACTOR SHALL CLOSE THE OPEN TRAVEL LANE ADJACENT TO THE WORK AREA USING APPROPRIATE TRAFFIC CONTROL MEANS AND METHODS UNLESS WORK IN THAT

THE CONTRACTOR SHALL NOT WORK SIMULTANEOUSLY ON BOTH SIDES OF AN OPEN TRAVEL WAY WITHIN THE SAME LOCATION ON A THE MAXIMUM LENGTH OF A LANE CLOSURE ON THE PROJECT SHALL BE ONE MILE, MEASURED FROM THE BEGINNING OF THE

THE CONTRACTOR SHALL BACKFILL AT 6:1 SLOPE UP TO THE EDGE AND ELEVATION OF EXISTING PAVEMENT IN AREAS ADJACENT TO AN OPENED TRAVEL LANE THAT HAS A DROP-OFF OF MORE THAN 3". WHEN BACKFILL IS REQUIRED, IT SHALL BE AT NO EXPENSE TO THE OWNER. THE MAXIMUM DIFFERENCE IN ELEVATION BETWEEN OPEN LANES OF TRAFFIC SHALL BE 2".

WHEN LANE CLOSURES ARE NOT IN EFFECT, CHANNELING DEVICES IN WORK AREAS SHALL BE SPACED NO GREATER THAN TWICE DURING INSTALLATION, PROPER TRAFFIC CONTROL DEVICES, SIGNS, ETC. BE INSTALLED TO ENSURE PUBLIC SAFETY IN ACCORDANCE WITH THE NORTH CAROLINA DEPARTMENT OF TRANSPORTATION'S STANDARDS AND SPECIFICATIONS ALL DISTURBED AREAS ARE TO BE FULLY RESTORED TO NCDOT MINIMUM ROADWAY STANDARDS.

MATERIALS AND WORKMANSHIP SHALL CONFORM TO THE NCDOT ROADWAY STANDARDS AND SPECIFICATIONS (LATEST EDITION)

VICINITY MAP

DATE: TITLE:

LAYOUT COORD: PLANNING MGR. DRAWING BY: SEPTEMBER 29, 2015

TRIANGLE

TRIANGLE SITE DESIGN, PLLC 4006 BARRETT DR, STE 203

RALEIGH, NC 27609 (919) 553-6570 LICENSE #P-0619

OWNER/DEVELOPER:

ATTN. WADE DAVIS 123 S. FRONT STREET

3RD FLOOR

REVISIONS:

AUTOZONE DEVELOPMENT, LLC

MEMPHIS, TN 38103-2107 PHONE: (901) 495-8701

For Bidding & Contractor Information Contact: F.W. Dodge Plan Room Tel: (615) 884-1017


FAX: (901) 495–8969 wade.davis@autozone.com

SEAL:

JOB NUMBER: 010048

COVER SHEET

SHEET NUMBER:

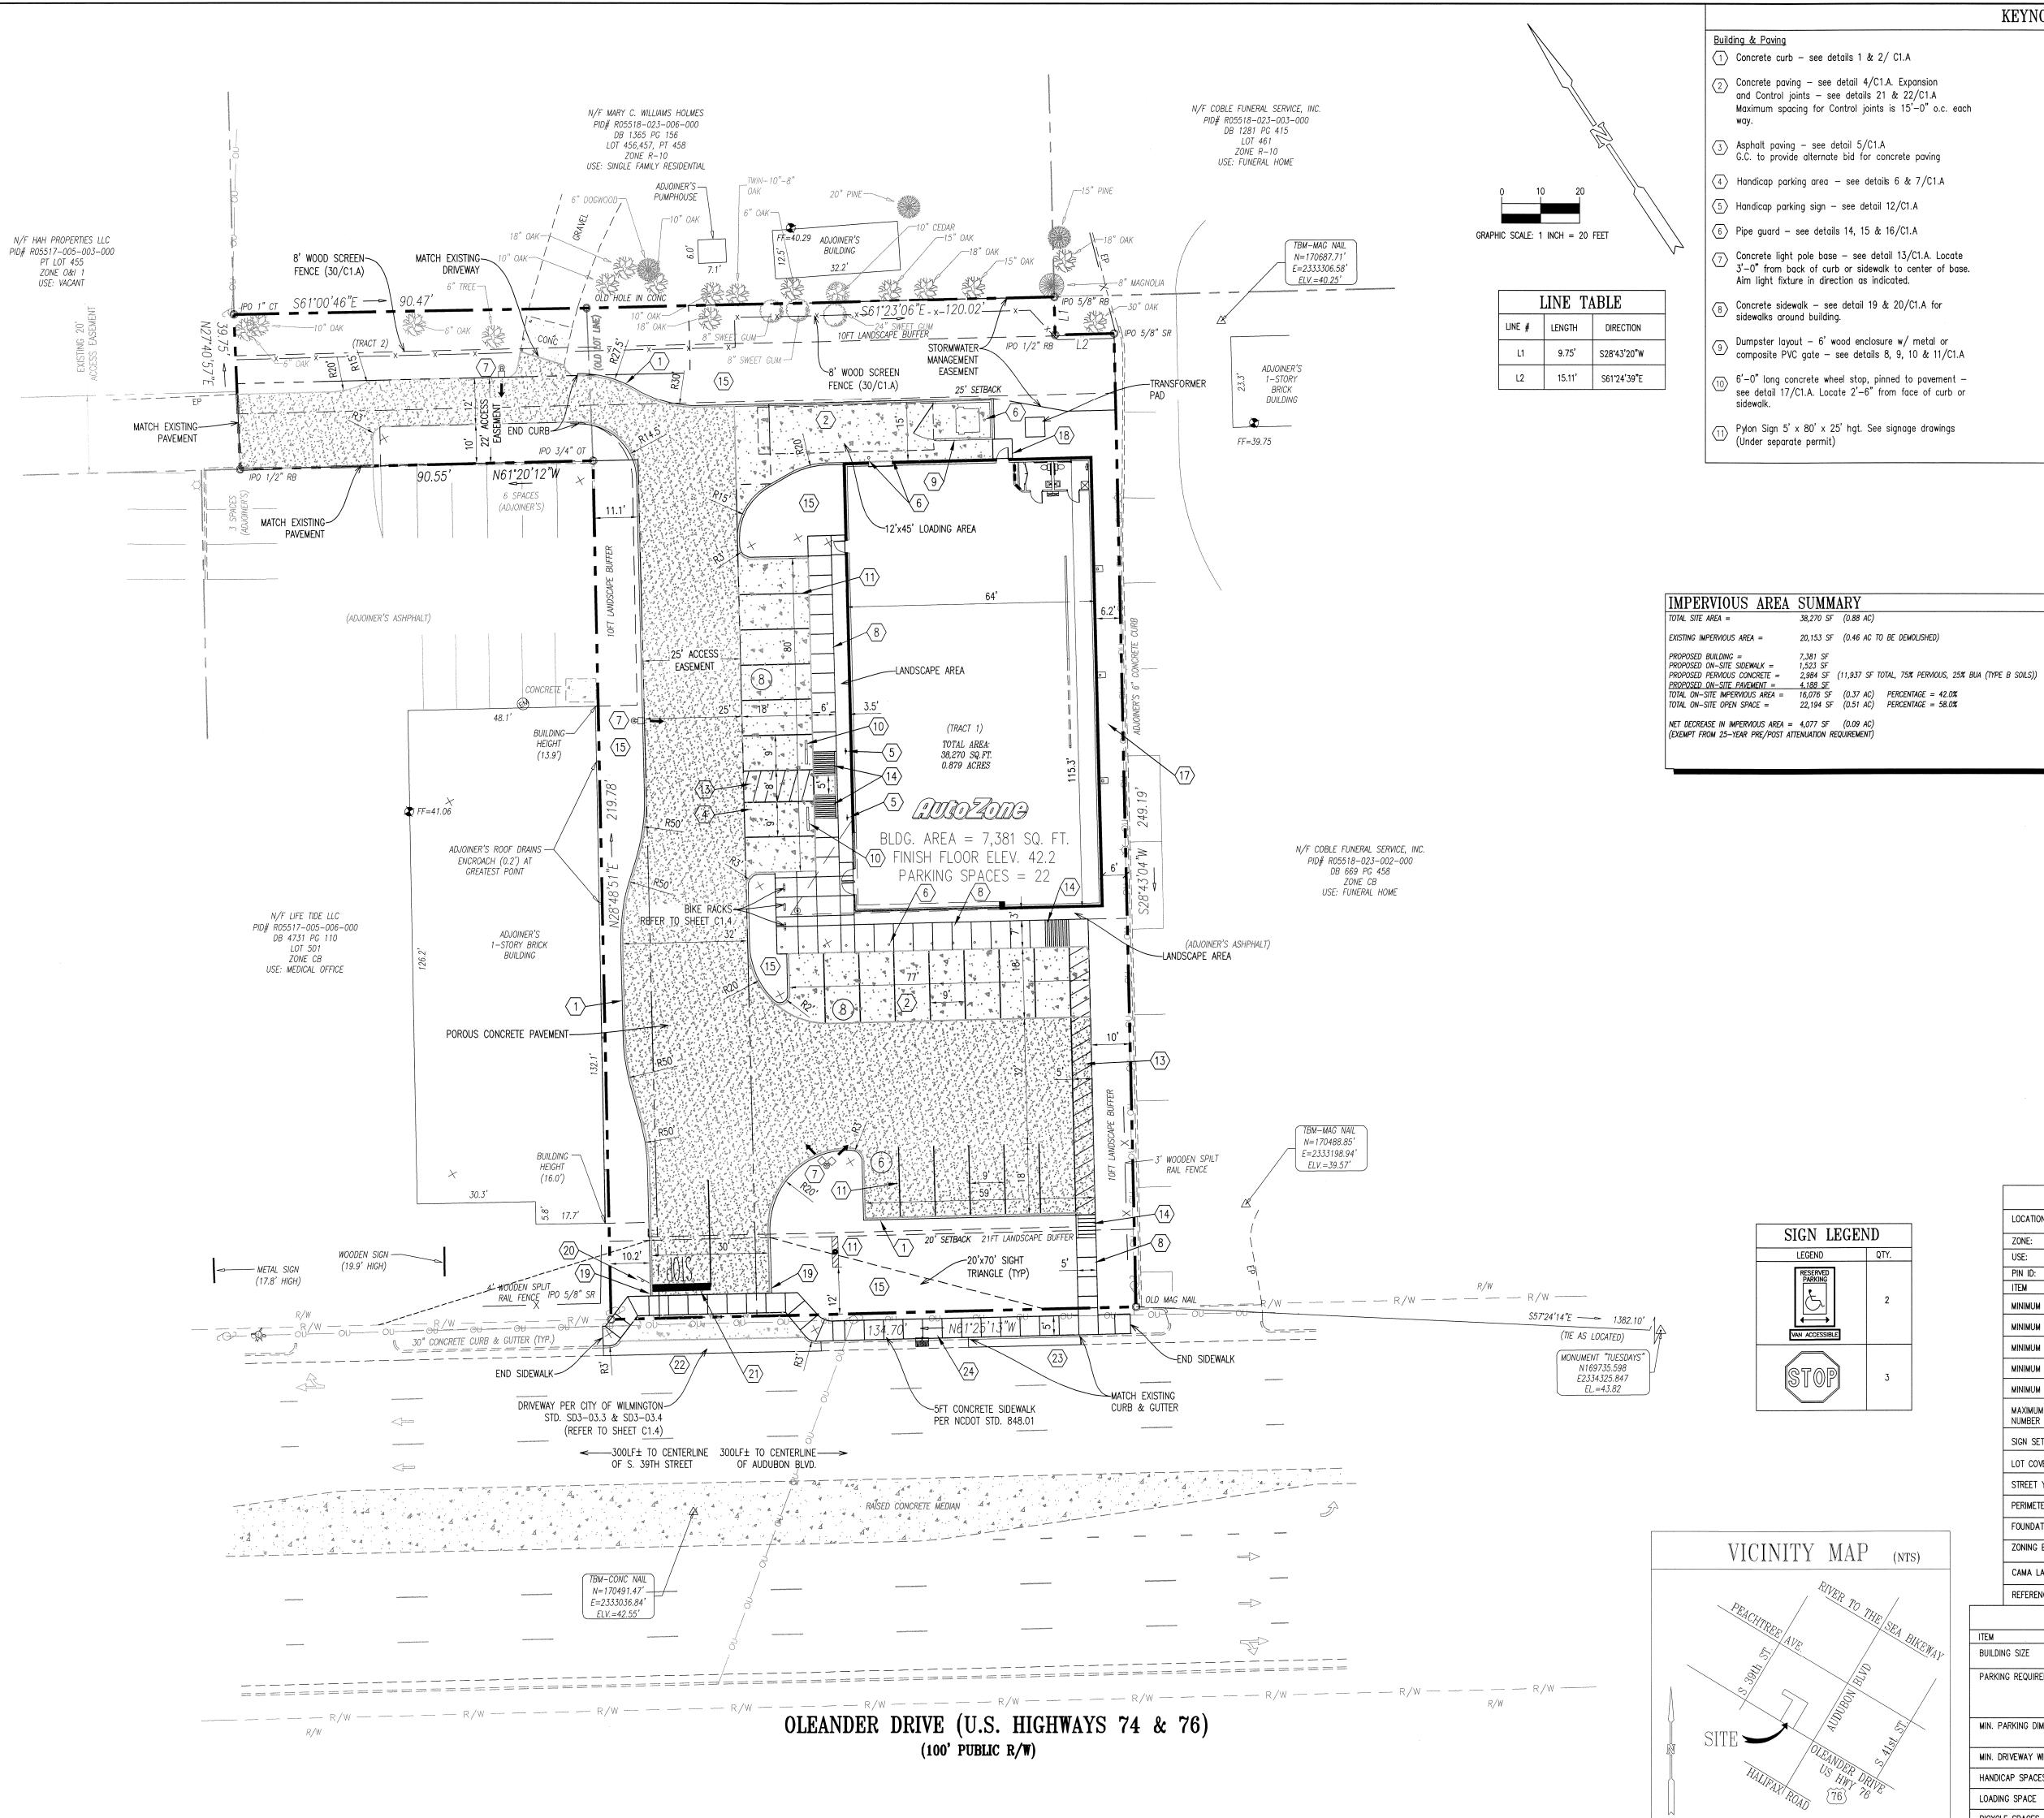

KEYNOTES

- (1) Concrete curb see details 1 & 2/ C1.A
- $\overline{2}$ Concrete paving see detail 4/C1.A. Expansion and Control joints — see details 21 & 22/C1.A Maximum spacing for Control joints is 15'-0" o.c. each
- $\sqrt{3}$ Asphalt paving see detail 5/C1.A G.C. to provide alternate bid for concrete paving
- 4 Handicap parking area see details 6 & 7/C1.A
- 5 Handicap parking sign see detail 12/C1.A
- $\langle 6 \rangle$ Pipe guard see details 14, 15 & 16/C1.A
- Concrete light pole base see detail 13/C1.A. Locate 3'-0" from back of curb or sidewalk to center of base.
- (8) Concrete sidewalk see detail 19 & 20/C1.A for sidewalks around building.
- 9 Dumpster layout 6' wood enclosure w/ metal or
- (10) 6'-0" long concrete wheel stop, pinned to pavement -
- Pylon Sign 5' x 80' x 25' hgt. See signage drawings (Under separate permit)

- $\langle 12 \rangle$ 4" wide parking stripe painted white (typ.)
 - (13) 4" wide diagonal stripes painted white @ 2 ft. o.c.
 - Concrete handicap ramp maximum slope 1:12 (8.33%) (per A.D.A. requirements). Maximum cross slope 1:50
 - New landscape area provide sod and 3" topsoil see sheet L1.0 for additional information
 - Slope grade from back of curb down to match the
 - (17) Connect building down spouts to storm drainage system
 - $\langle 18 \rangle$ 5' x 5' concrete pad
 - (19) Slope end of curb 4:1
 - $\langle 20 \rangle$ Stop Sign see detail 26/C1.A

existing grade @ property line.

- (21) Pavement markings see detail 25 & 26/C1.A
- (22) New curb cut & approach per local codes & specs.
- New concrete curb & gutter to meet all local & state D.O.T. requirements
- New sidewalk to meet all local & state D.O.T. requirements
- Remove existing curb, gutter, pavement, sidewalk and back fill per local & state D.O.T. requirements



- Property line and right-of-way monuments shall not be disturbed by construction. If disturbed, they shall be reset to their original locations at the Contractor's expense by a Registered Land Surveyor.
- Proof Roll Building and all parking areas. Notify AutoZone Inc. of any unacceptable areas.
- Building dimensions shown on the Civil Engineering Plans are for reference purposes only, Contractor shall use the Architectural and Structural Plans for exact Building dimensions.
- . All site dimensions are referenced to the face of curbs or edge of paving unless otherwise noted.
- All sidewalks, curb and gutter, street paving, curb cuts, driveway approaches, handicap ramps, etc. constructed outside the property line in the right-of-way shall conform to all municipal and/or State specifications and requirements.
- 6. All disturbance incurred to any adjoining property due to construction or demolition shall be restored to the previous condition or better, and to the satisfaction of the City or State
- The Contractor shall provide As-Built records of all construction (including underground utilities) to AutoZone Inc. at the end of


PAVEMENT LEGEND

ASPHALT PAVING — SEE DETAIL 5/C1.A (ALTERNATE BID) CONCRETE PAVING — SEE DETAIL 4/C1.A

CONCRETE PAVING - SEE DETAIL 4/C1.A

POROUS CONCRETE PAVEMENT - SEE DETAIL SHEET C1.5

VICINITY MAP (NTS)

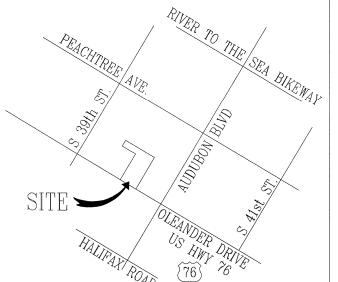

BULK AREA REQUIREMENTS LOCATION: 3913 OLEANDER DRIVE (US HWY 76) WLMINGTON, NORTH CAROLINA CB (COMMUNITY BUSINESS) USE: RETAIL AUTO PARTS SALES PIN ID: R05518-023-001-000 REQUIREMENTS PROVIDED 0.879 AC 0.5 AC MINIMUM LOT AREA 80FT 135FT MINIMUM LOT FRONTAGE 102FT MINIMUM FRONT SETBACK MINIMUM SIDE SETBACK 25FT (ADJACENT RESIDENTIAL) | 25FT MINIMUM REAR SETBACK 45 FT (3 STORIES) 21FT± (1 STORY) MAXIMUM BUILDING HEIGHT NUMBER OF STORIES 10 FT 12 FT SIGN SETBACK LOT COVERAGE (BUILDING) 20FT STREET YARD 20FT STREET YARD STREET YARD BUFFER 10FT PARKING BUFFER 10FT PARKING BUFFER PERIMETER PARKING BUFFER FOUNDATION PLANTINGS 12% OF BUILDING FACE AREA | 12% OF BUILDING FACE AREA 10FT ADJACENT RESIDENTIAL 10FT ADJACENT RESIDENTIAL ZONING BUFFER WITH FENCE

CAMA LAND USE CLASSIFICATION: DEVELOPED REFERENCE IS MADE TO THE CITY OF WILMINGTON ZONING ORDINANCE

PARKING INFORMATION								
ITEM	REQUIREMENTS	PROVIDED						
BUILDING SIZE	N/A	7,381 SF						
PARKING REQUIRED	MIN SPACES = 18 (1 SPACE/400 SF GFA) MAX SPACES = 37 (1 SPACE/200 SF GFA)	22 SPACES						
MIN. PARKING DIM.	8.5 FT x 18 FT	9 FT x 18 FT						
MIN. DRIVEWAY WIDTH	24 FT	30 FT						
HANDICAP SPACES	2 SPACE	2 SPACES						
LOADING SPACE	1 REQUIRED (12'x45')	1 SPACE						


5 SPACES

5 SPACES

BICYCLE SPACES



CONSULTANT: TRIANGLE SITE DESIGN, PLLC 4006 BARRETT DR, STE 203 RALEIGH, NC 27609 (919) 553-6570 LICENSE #P-0619

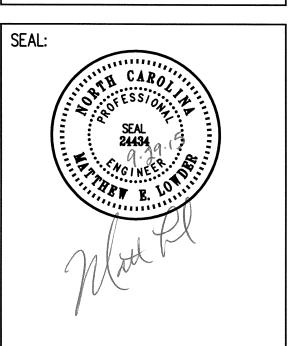

6486 (92 STORE 3913 C (US Hv

OWNER/DEVELOPER: AUTOZONE DEVELOPMENT, LLC ATTN. WADE DAVIS 123 S. FRONT STREET 3RD FLOOR MEMPHIS, TN 38103-2107 PHONE: (901) 495-8701 FAX: (901) 495-8969 wade.davis@autozone.com For Bidding & Contractor Information Contact:

F.W. Dodge Plan Room Tel: (615) 884-1017


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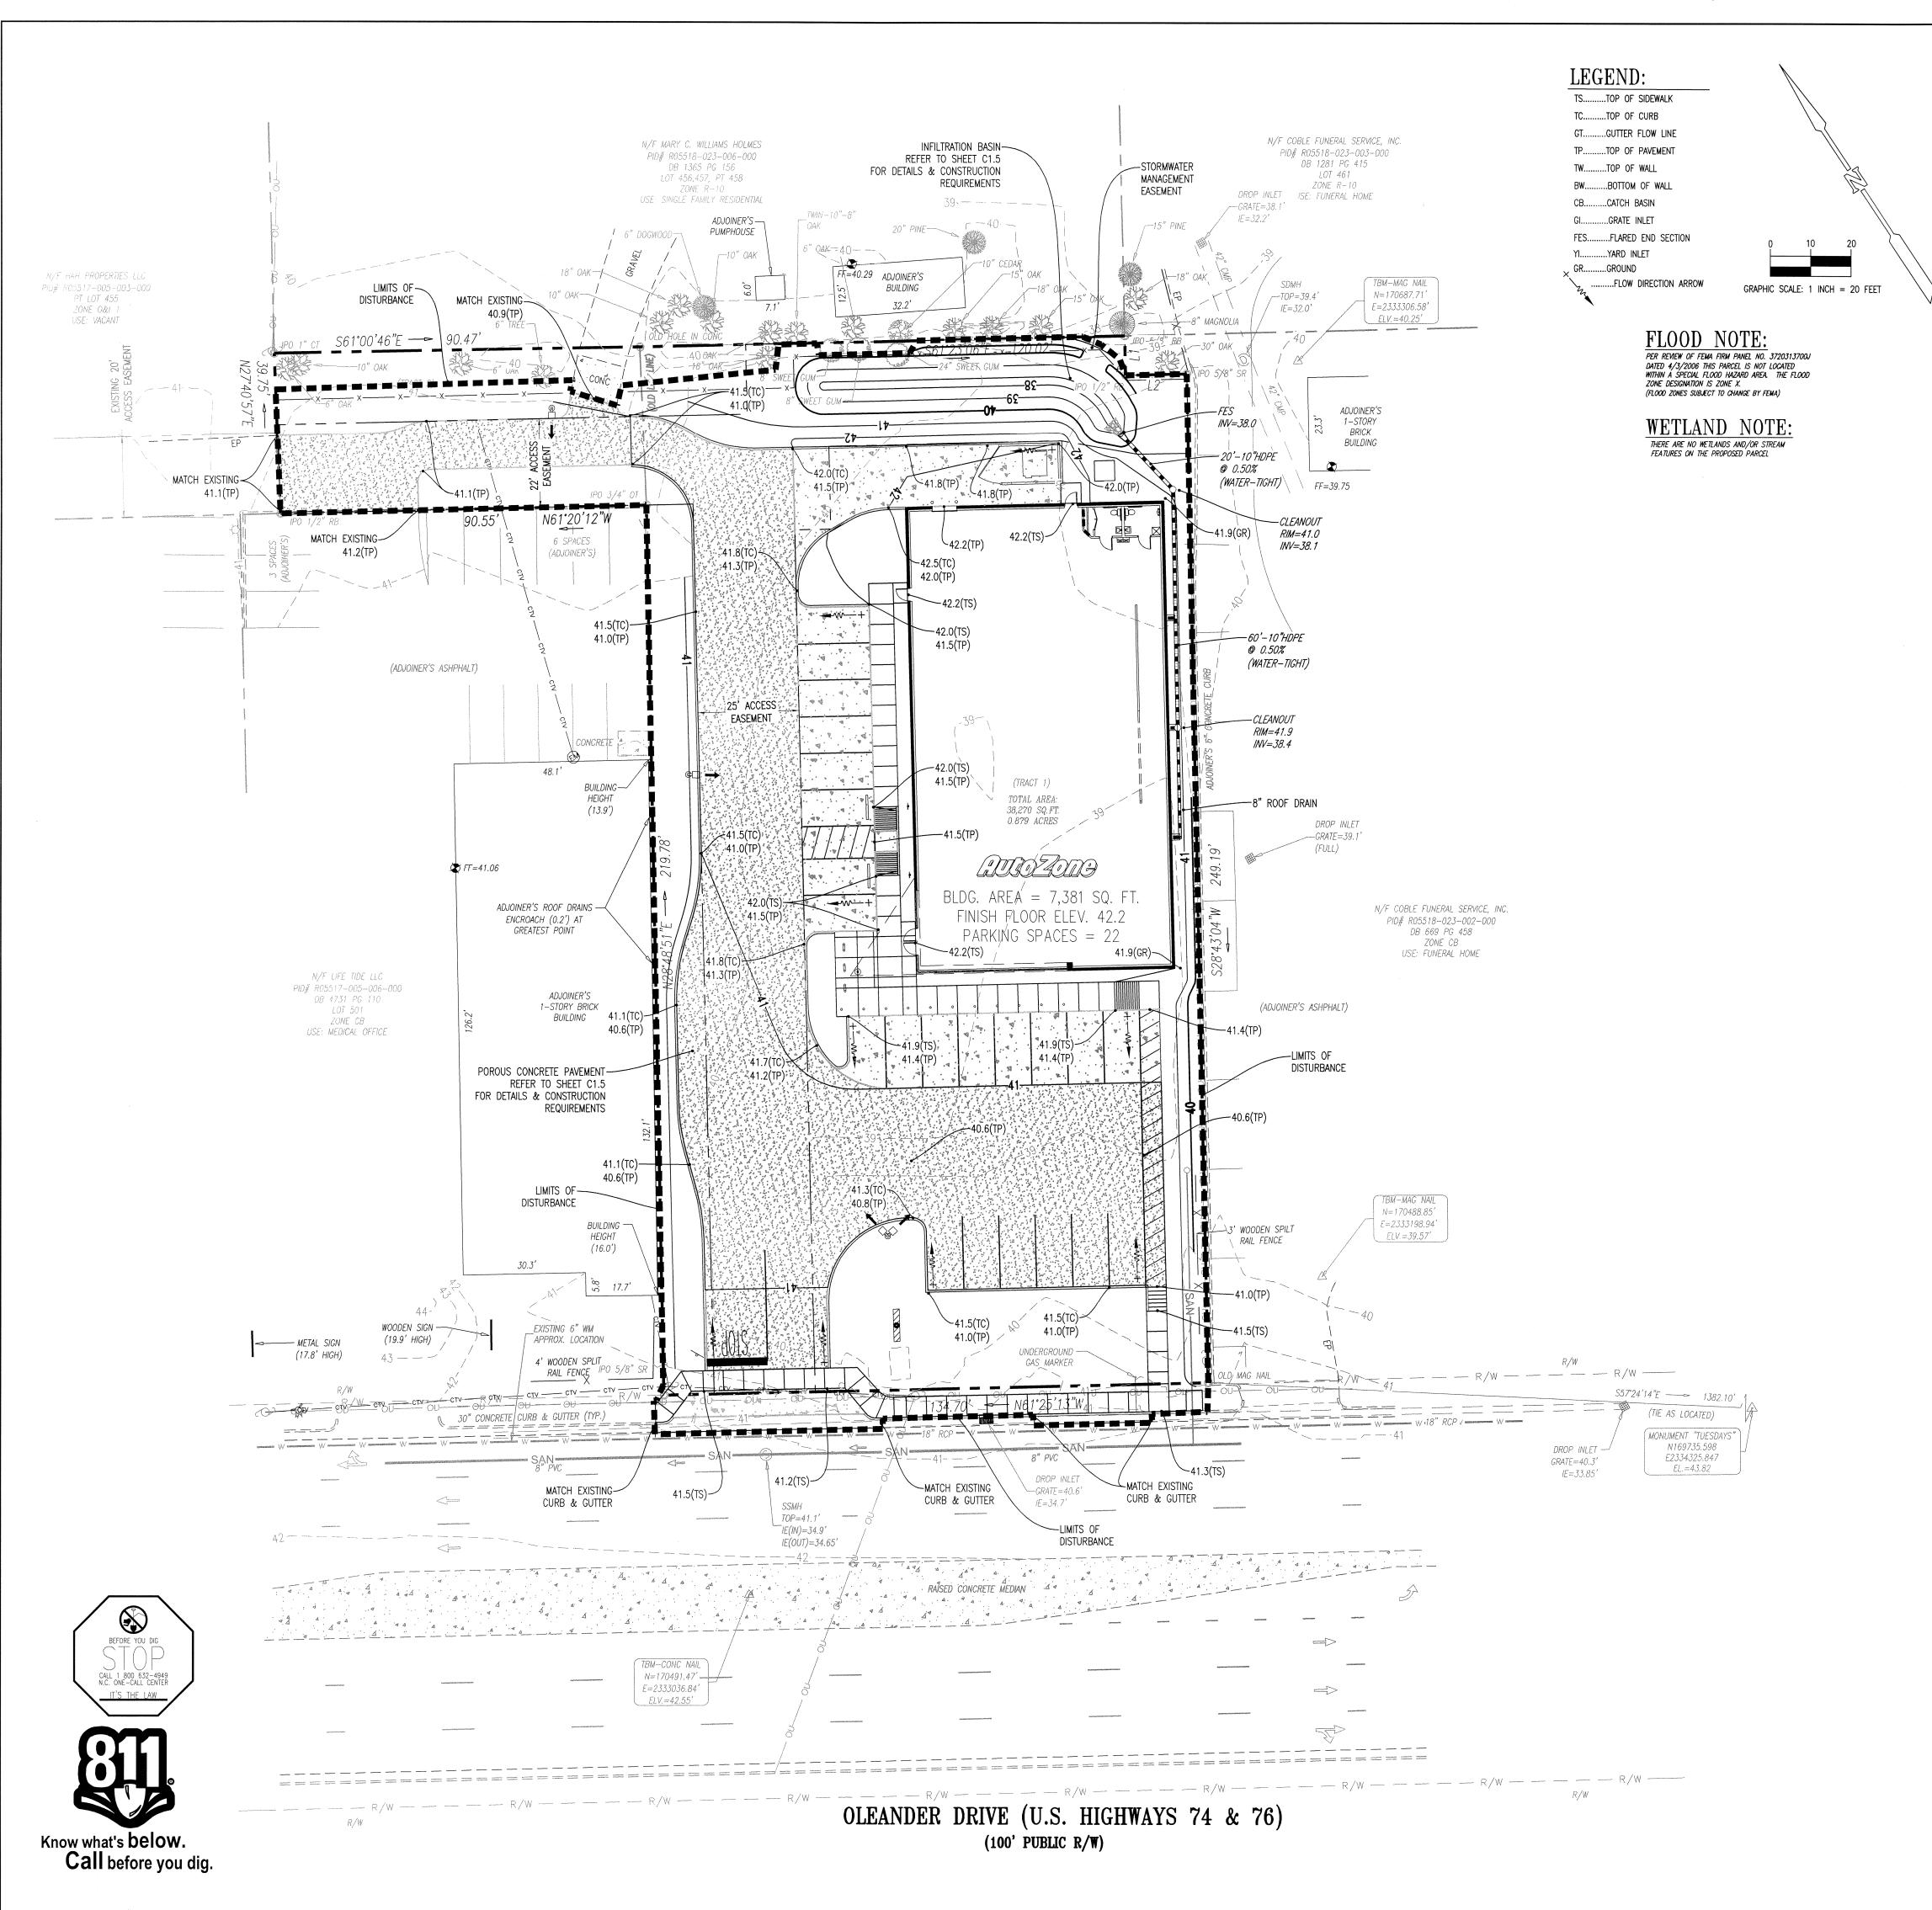
LAYOUT COORD: PLANNING MGR. DRAWING BY:

SEPTEMBER 29, 2015 DATE: JOB NUMBER:

SITE PLAN


SHEET NUMBER:



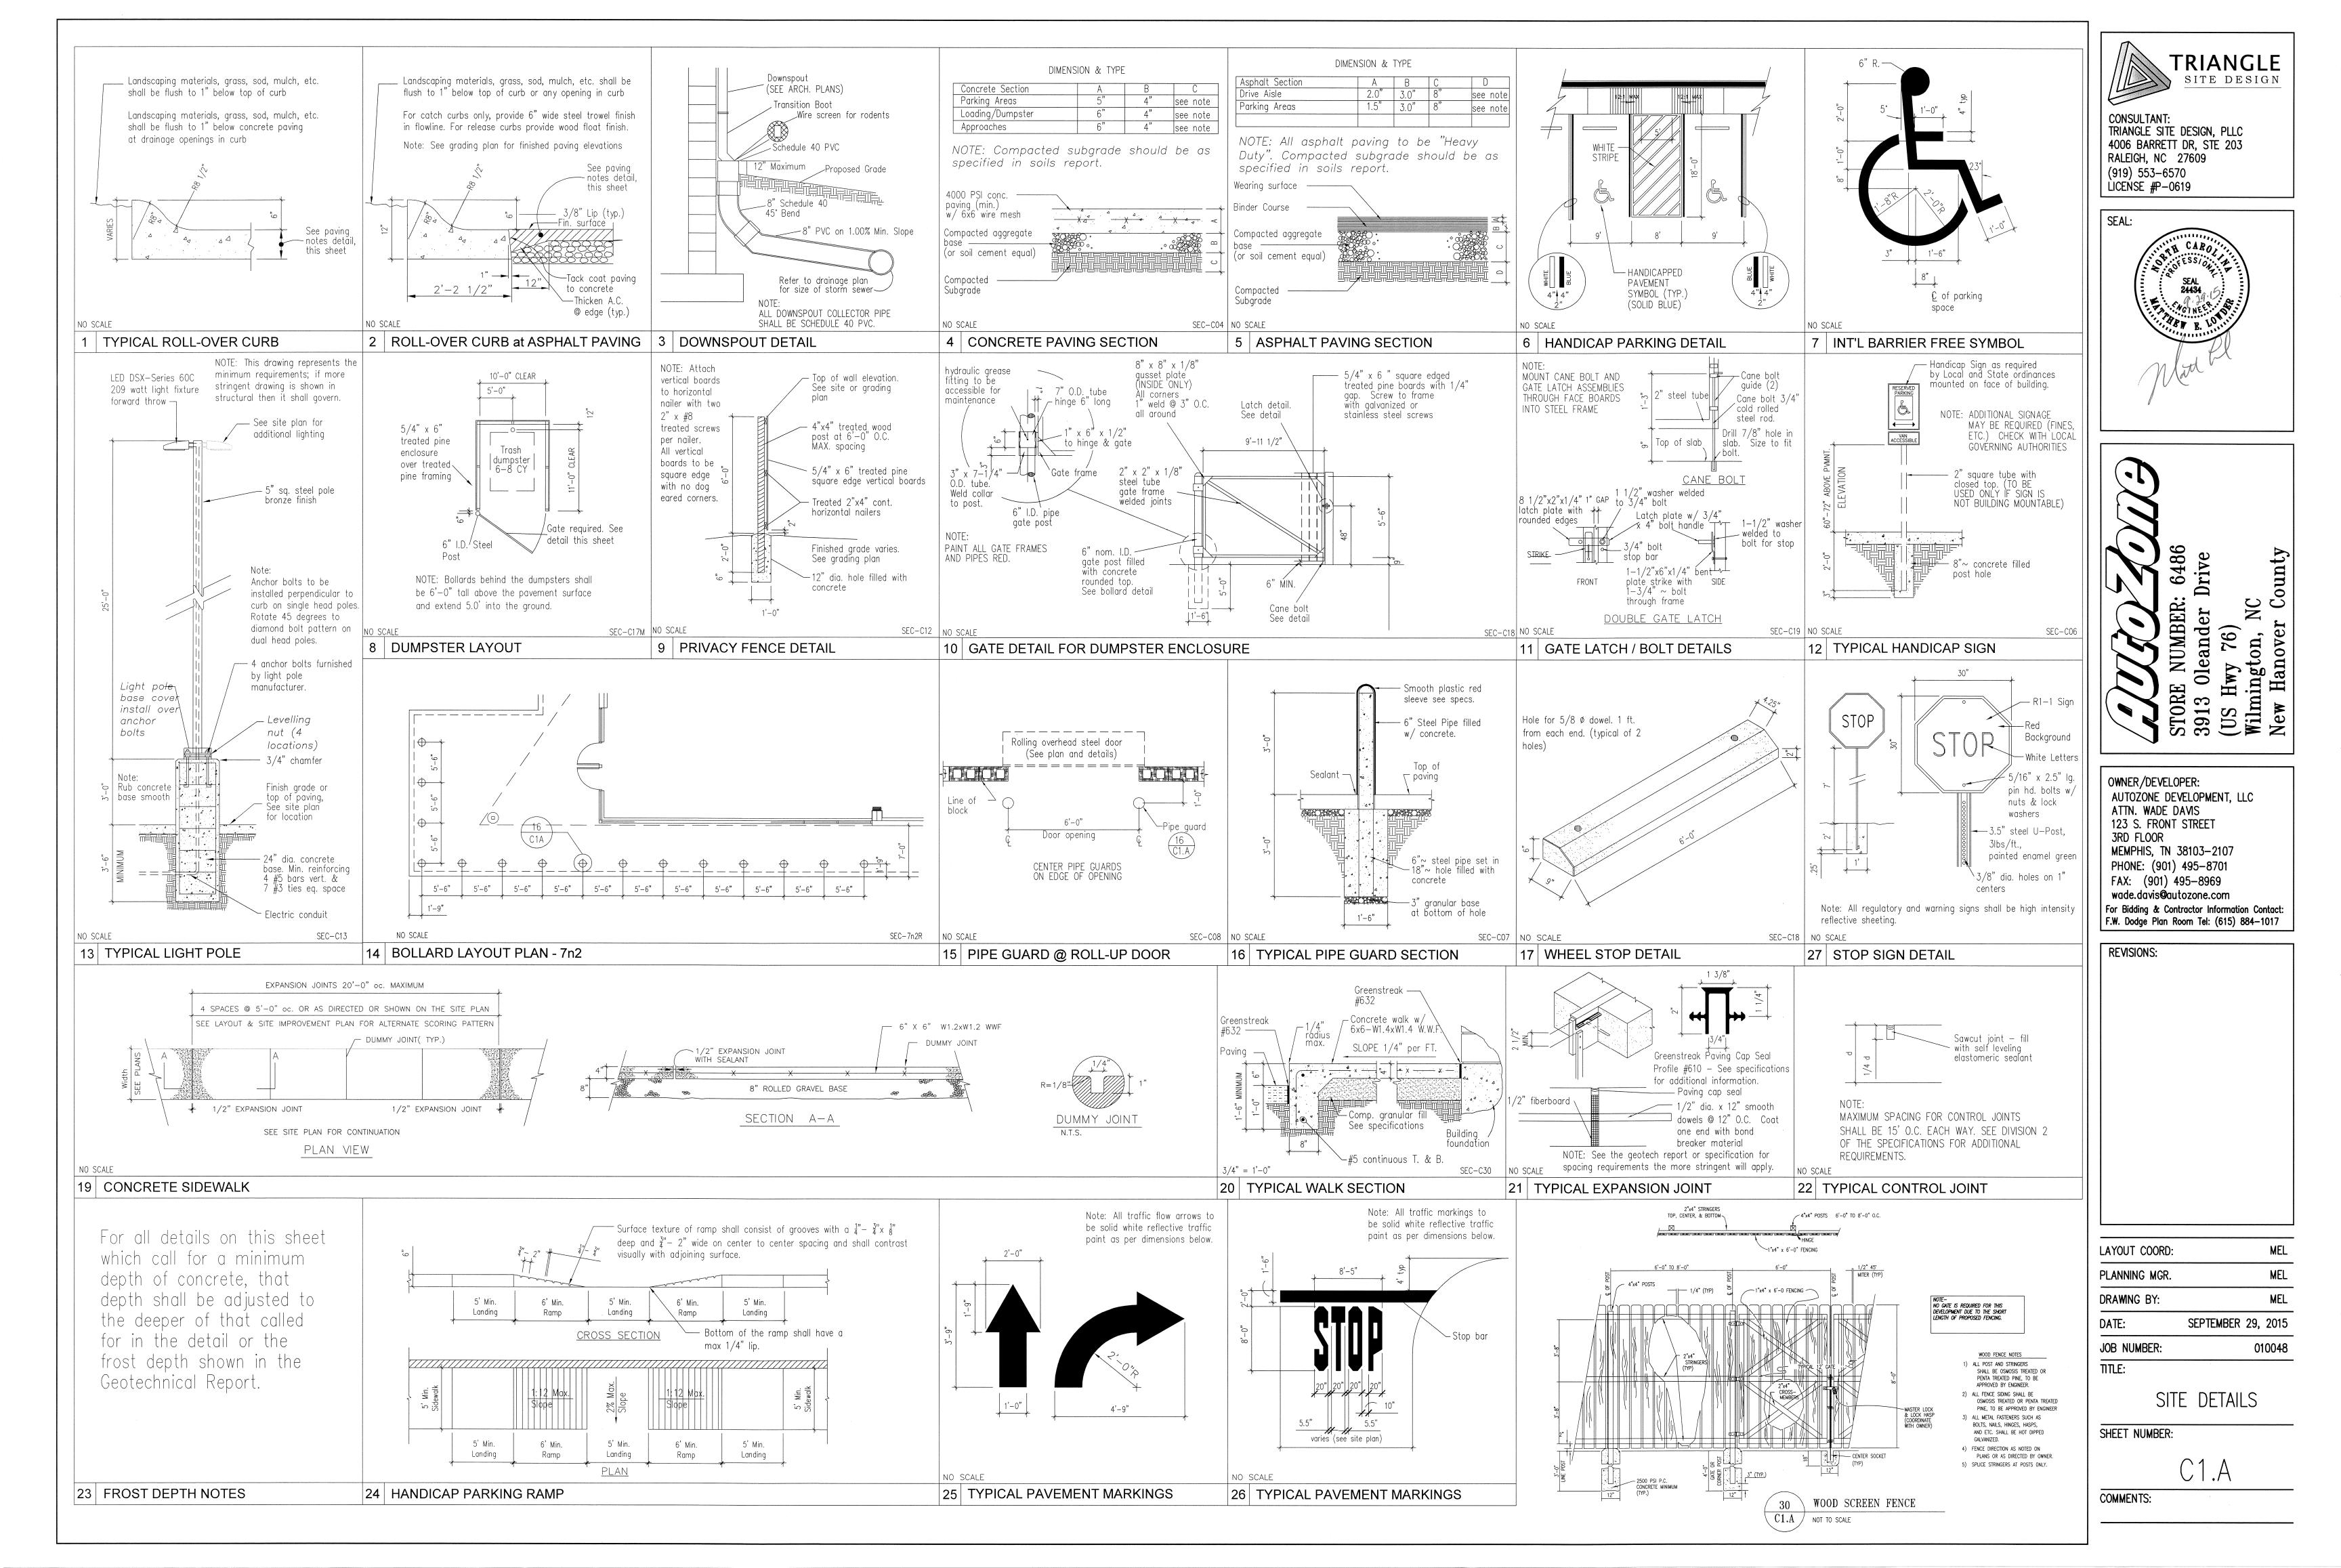

GRADING NOTES:

- REFER TO THE SITE PLAN FOR RELATED NOTES
 - 2. ALL CONTOURS AND SPOT ELEVATIONS REFLECT FINISHED GRADES.
 - 3. ALL ELEVATIONS ARE IN REFERENCE TO THE BENCHMARK, AND THIS MUST BE VERIFIED BY THE GENERAL CONTRACTOR PRIOR TO GROUND BREAKING.
 - 4. THE CONTRACTOR SHALL IMMEDIATELY REPORT TO OWNER ANY DISCREPANCIES FOUND BETWEEN ACTUAL FIELD CONDITIONS AND CONSTRUCTION DOCUMENTS AND SHALL WAIT FOR INSTRUCTION PRIOR TO PROCEEDING.
 - 5. THE CONTRACTOR SHALL BE RESPONSIBLE FOR LOCATING AND PROTECTING EXISTING UTILITIES, AND SHALL REPAIR ALL DAMAGE TO
 - EXISTING UTILITIES THAT OCCUR DURING CONSTRUCTION.
 - 6. THE CONTRACTOR SHALL BLEND NEW EARTHWORK SMOOTHLY TO TRANSITION BACK TO EXISTING GRADE.
 - 7. LIMITS OF CLEARING SHOWN ON GRADING PLAN ARE BASED UPON THE APPROXIMATE CUT AND FILL SLOPE LIMITS, OR OTHER
 - 8. THE PROPOSED CONTOURS SHOWN IN DRIVES AND PARKING LOTS AND SIDEWALKS ARE FINISHED ELEVATIONS INCLUDING ASPHALT. REFER TO PAVEMENT CROSS SECTION DATA TO ESTABLISH CORRECT SUB-BASE OR AGGREGATE BASE COURSE ELEVATIONS TO BE
 - 9. THE CONTRACTOR SHALL ENSURE POSITIVE DRAINAGE SO THAT RUNOFF WILL DRAIN BY GRAVITY FLOW ACROSS NEW PAVEMENT AREAS TO NEW OR EXISTING DRAINAGE INLETS OR SHEET OVERLAND.
 - 10. ANY GRADING, BEYOND THE LIMITS OF CONSTRUCTION AS SHOWN ON THE GRADING PLAN, IS SUBJECT TO A FINE.
 - 11. GRADING MORE THAN ONE ACRE WITHOUT AN APPROVED EROSION CONTROL PLAN IS SUBJECT TO A FINE.
 - 12. STABILIZATION IS THE BEST FORM OF EROSION CONTROL. TEMPORARY SEEDING IS NECESSARY TO ACHIEVE EROSION CONTROL ON DENUDED AREAS AND ESPECIALLY WHEN THE CONSTRUCTION SEQUENCE REQUIRES IT.
 - 13. ALL DISTURBED AREAS ARE TO BE SEEDED OR LANDSCAPED WITHIN 14 DAYS OF COMPLETION OF GRADING.
 - 14. EXISTING GRADES, CONTOURS, UTILITIES AND OTHER EXISTING FEATURES FROM FIELD RUN SURVEY.
 - 15. THE CONTRACTOR SHALL INCLUDE IN THE CONTRACT PRICE ANY DE-WATERING NECESSARY TO CONSTRUCT THE PROJECT AS SHOWN ON THE PLANS.
 - 16. THE CONTRACTOR IS RESPONSIBLE FOR THE DESIGN AND IMPLEMENTATION OF ALL SHEETING, SHORING, BRACING AND SPECIAL EXCAVATION MEASURES REQUIRED TO MEET OSHA, FEDERAL, STATE, AND LOCAL REGULATIONS PURSUANT TO THE INSTALLATION OF THE WORK INDICATED ON THESE DRAWINGS. THE DESIGN ENGINEER ACCEPTS NO RESPONSIBILITY FOR THE DESIGN(S) TO INSTALL
 - 17. THE CONTRACTOR SHALL REFER TO THE ARCHITECTURAL PLANS FOR EXACT LOCATION, ELEVATION, AND DIMENSIONS OF EXIT DOORS, RAMPS, BUILDING DIMENSIONS, AND EXACT BUILDING UTILITY ENTRANCE LOCATIONS.
 - 18. ALL FILL MATERIALS, EXISTING BUILDING FOUNDATIONS, PAVEMENT AND UTILITY STRUCTURES, TOPSOIL, AND ANY OTHER DELETERIOUS MATERIALS SHALL BE COMPLETELY REMOVED FROM WITHIN THE BEARING ZONE BELOW THE STRUCTURE.
 - 19. ALL FOUNDATION EXCAVATION SHALL BE INSPECTED BY A QUALIFIED GEOTECHNICAL REPRESENTATIVE TO DETERMINE WHETHER UNSUITABLE MATERIAL MUST BE REMOVED. ALL UNDESIRABLE MATERIAL SHALL BE REMOVED, BACKFILLED AND COMPACTED AS REQUIRED BY THE GEOTECHNICAL REPRESENTATIVE.
 - 20. ALL CUT OR FILL SLOPES SHALL BE 3:1 OR FLATTER UNLESS OTHERWISE NOTED OR DEPICTED.
 - 21. THE CONTRACTOR SHALL ADHERE TO ALL TERMS & CONDITIONS AS OUTLINED IN THE GENERAL N.P.D.E.S PERMIT FOR STORM WATER DISCHARGE ASSOCIATED WITH CONSTRUCTION ACTIVITIES.
 - 22. CONTRACTOR SHALL ADJUST AND/OR CUT EXISTING PAVEMENT AS NECESSARY TO ASSURE A SMOOTH FIT AND CONTINUOUS GRADE.
 - 23. CONTRACTOR SHALL ENSURE POSITIVE DRAINAGE AWAY FROM BUILDINGS FOR ALL NATURAL AND PAVED AREAS.
 - 24. ALL UN-SURFACED AREAS DISTURBED BY GRADING OPERATION SHALL RECEIVE 4 INCHES OF TOPSOIL CONTRACTOR SHALL APPLY STABILIZATION FABRIC TO ALL SLOPES 3H:1V OR STEEPER.
 - 25. CONSTRUCTION SHALL COMPLY WITH ALL APPLICABLE GOVERNING CODES AND BE CONSTRUCTED TO SAME.

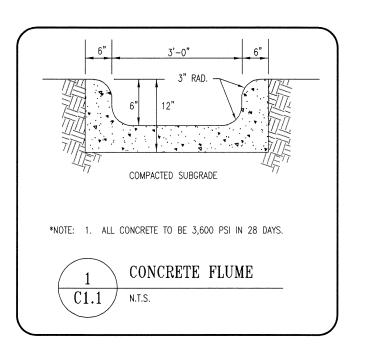


DRAINAGE NOTES:

1. A MINIMUM GRADE OF 0.50 % SHALL BE MAINTAINED ON ALL PIPES, UNLESS OTHERWISE NOTED.

- 2. PIPE LENGTHS AND SLOPES INDICATED ON THE PLANS ARE APPROXIMATE ONLY.
- 3. UNDERGROUND UTILITY LINES SHALL BE INSTALLED IN ACCORDANCE WITH THE FOLLOWING STANDARDS IN ADDITION TO OTHER APPLICABLE CRITERIA:
 - A. NO MORE THAN 500 LF OF TRENCH MAY BE OPENED AT ONE TIME. B. EXCAVATED MATERIAL SHALL BE PLACED ON THE UPHILL SIDE OF TRENCHES.
 - C. EFFLUENT FROM DE-WATERING OPERATIONS SHALL BE FILTERED OR PASSED THROUGH AN APPROVED SEDIMENT TRAPPING DEVICE, OR BOTH, AND DISCHARGED IN A MANNER THAT DOES NOT ADVERSELY AFFECT FLOWING STREAMS OR OFF-SITE
- D. MATERIAL USED FOR BACK-FILLING TRENCHES SHALL BE PROPERLY COMPACTED IN ORDER TO MINIMIZE EROSION AND PROMOTE STABILIZATION. E. RE-STABALIZATION SHALL BE ACCOMPLISHED IN ACCORDANCE WITH THE EROSION AND SEDIMENT CONTROL REGULATIONS. F. APPLICABLE SAFETY REGULATIONS SHALL BE COMPLIED WITH.
- 4. CATCH BASINS, MANHOLES, FRAMES, GRATES, ETC. SHALL MEET THE REQUIREMENTS OF THE LATEST EDITION OF THE NORTH CAROLINA DEPARTMENT OF TRANSPORTATION STANDARD DRAWINGS. REFERENCE THE FOLLOWING STANDARD DETAILS:
 - 840.03 FRAME, GRATES, AND HOOD FOR CATCH BASINS 840.04 - CONCRETE OPEN THROAT CATCH BASIN 840.14 - CONCRETE DROP INLET 840.16 - DROP INLET FRAME AND GRATES
 - 840.35 TRAFFIC BEARING GRATED DROP INLET 840.52 - PRECAST MANHOLE
- 840.31 CONCRETE JUNCTION BOX 840.45 — PRECAST DRAINAGE STRUCTURE 838.80 - PRECAST CONCRETE ENDWALL
- 5. ALL PIPES SHALL BE LAID ON STRAIGHT ALIGNMENTS AND EVEN GRADES USING A PIPE LASER OR OTHER ACCURATE METHOD.
- 6. STORM PIPE SHALL BE AS FOLLOW UNLESS OTHERWISE NOTED: TYPE 1: RCP, CLASS III PER ASTM C-76, WITH FLEXIBLE PLASTIC BITUMEN GASKETS AT JOINTS.
- TYPE 2: HIGH DENSITY POLYETHYLENE PIPE (HDPE) AASHTO DESIGNATION M252 TYPE S, M294 TYPE S AND MP7-97 TYPE S, SMOOTH INTERIOR/ANNULAR EXTERIOR. ONLY PERMITTED WHEN SPECIFICALLY INDICATED ON THE CONSTRUCTION DRAWINGS. PIPE SHALL BE INSTALLED IN ACCORDANCE WITH PIPE MANUFACTURER'S INSTALLATION GUIDELINES. PIPE JOINTS AND FITTINGS SHALL BE WATERTIGHT.
- 7. ALL STORM DRAINAGE WITHIN THE PUBLIC ROADS SHALL BE CLASS III REINFORCED CONCRETE PIPE UNLESS OTHERWISE NOTED.
- 8. EXISTING DRAINAGE STRUCTURES TO BE INSPECTED AND REPAIRED AS NEEDED, AND EXISTING PIPES TO BE CLEANED OUT TO REMOVE SILT AND DEBRIS.
- 9. IF ANY EXISTING STRUCTURES TO REMAIN ARE DAMAGED DURING CONSTRUCTION IT SHALL BE THE CONTRACTORS RESPONSIBILITY TO REPAIR AND/OR REPLACE THE EXISTING STRUCTURE AS NECESSARY TO RETURN IT TO EXISTING CONDITIONS OR BETTER.
- 10. ALL STORM PIPE ENTERING STRUCTURES SHALL BE GROUTED TO ASSURE CONNECTION AT STRUCTURE IS WATERTIGHT.
- 11. PRECAST STRUCTURES MAYBE USED AT CONTRACTORS OPTION.
- 12. ALL STORM SEWER MANHOLES IN PAVED AREAS SHALL BE FLUSH WITH PAVEMENT, AND SHALL HAVE TRAFFIC BEARING RING & COVERS. MANHOLES IN UNPAVED AREAS SHALL BE 6" ABOVE FINISH GRADE. LIDS SHALL BE LABELED "STORM SEWER".
- 13. STRUCTURE TOP ELEVATIONS SHOWN HERE ARE APPROXIMATE. CONTRACTOR SHALL ADJUST AS NECESSARY.
- 14. RIM ELEVATIONS AS NOTED ARE TO THE GUTTER FLOW LINE.



CONSULTANT: TRIANGLE SITE DESIGN, PLLC 4006 BARRETT DR, STE 203 RALEIGH, NC 27609 (919) 553–6570 LICENSE #P-0619

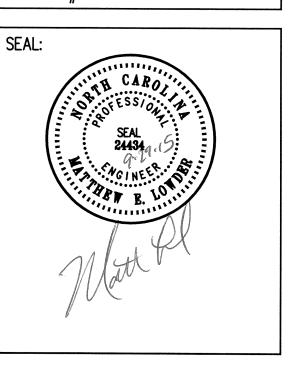

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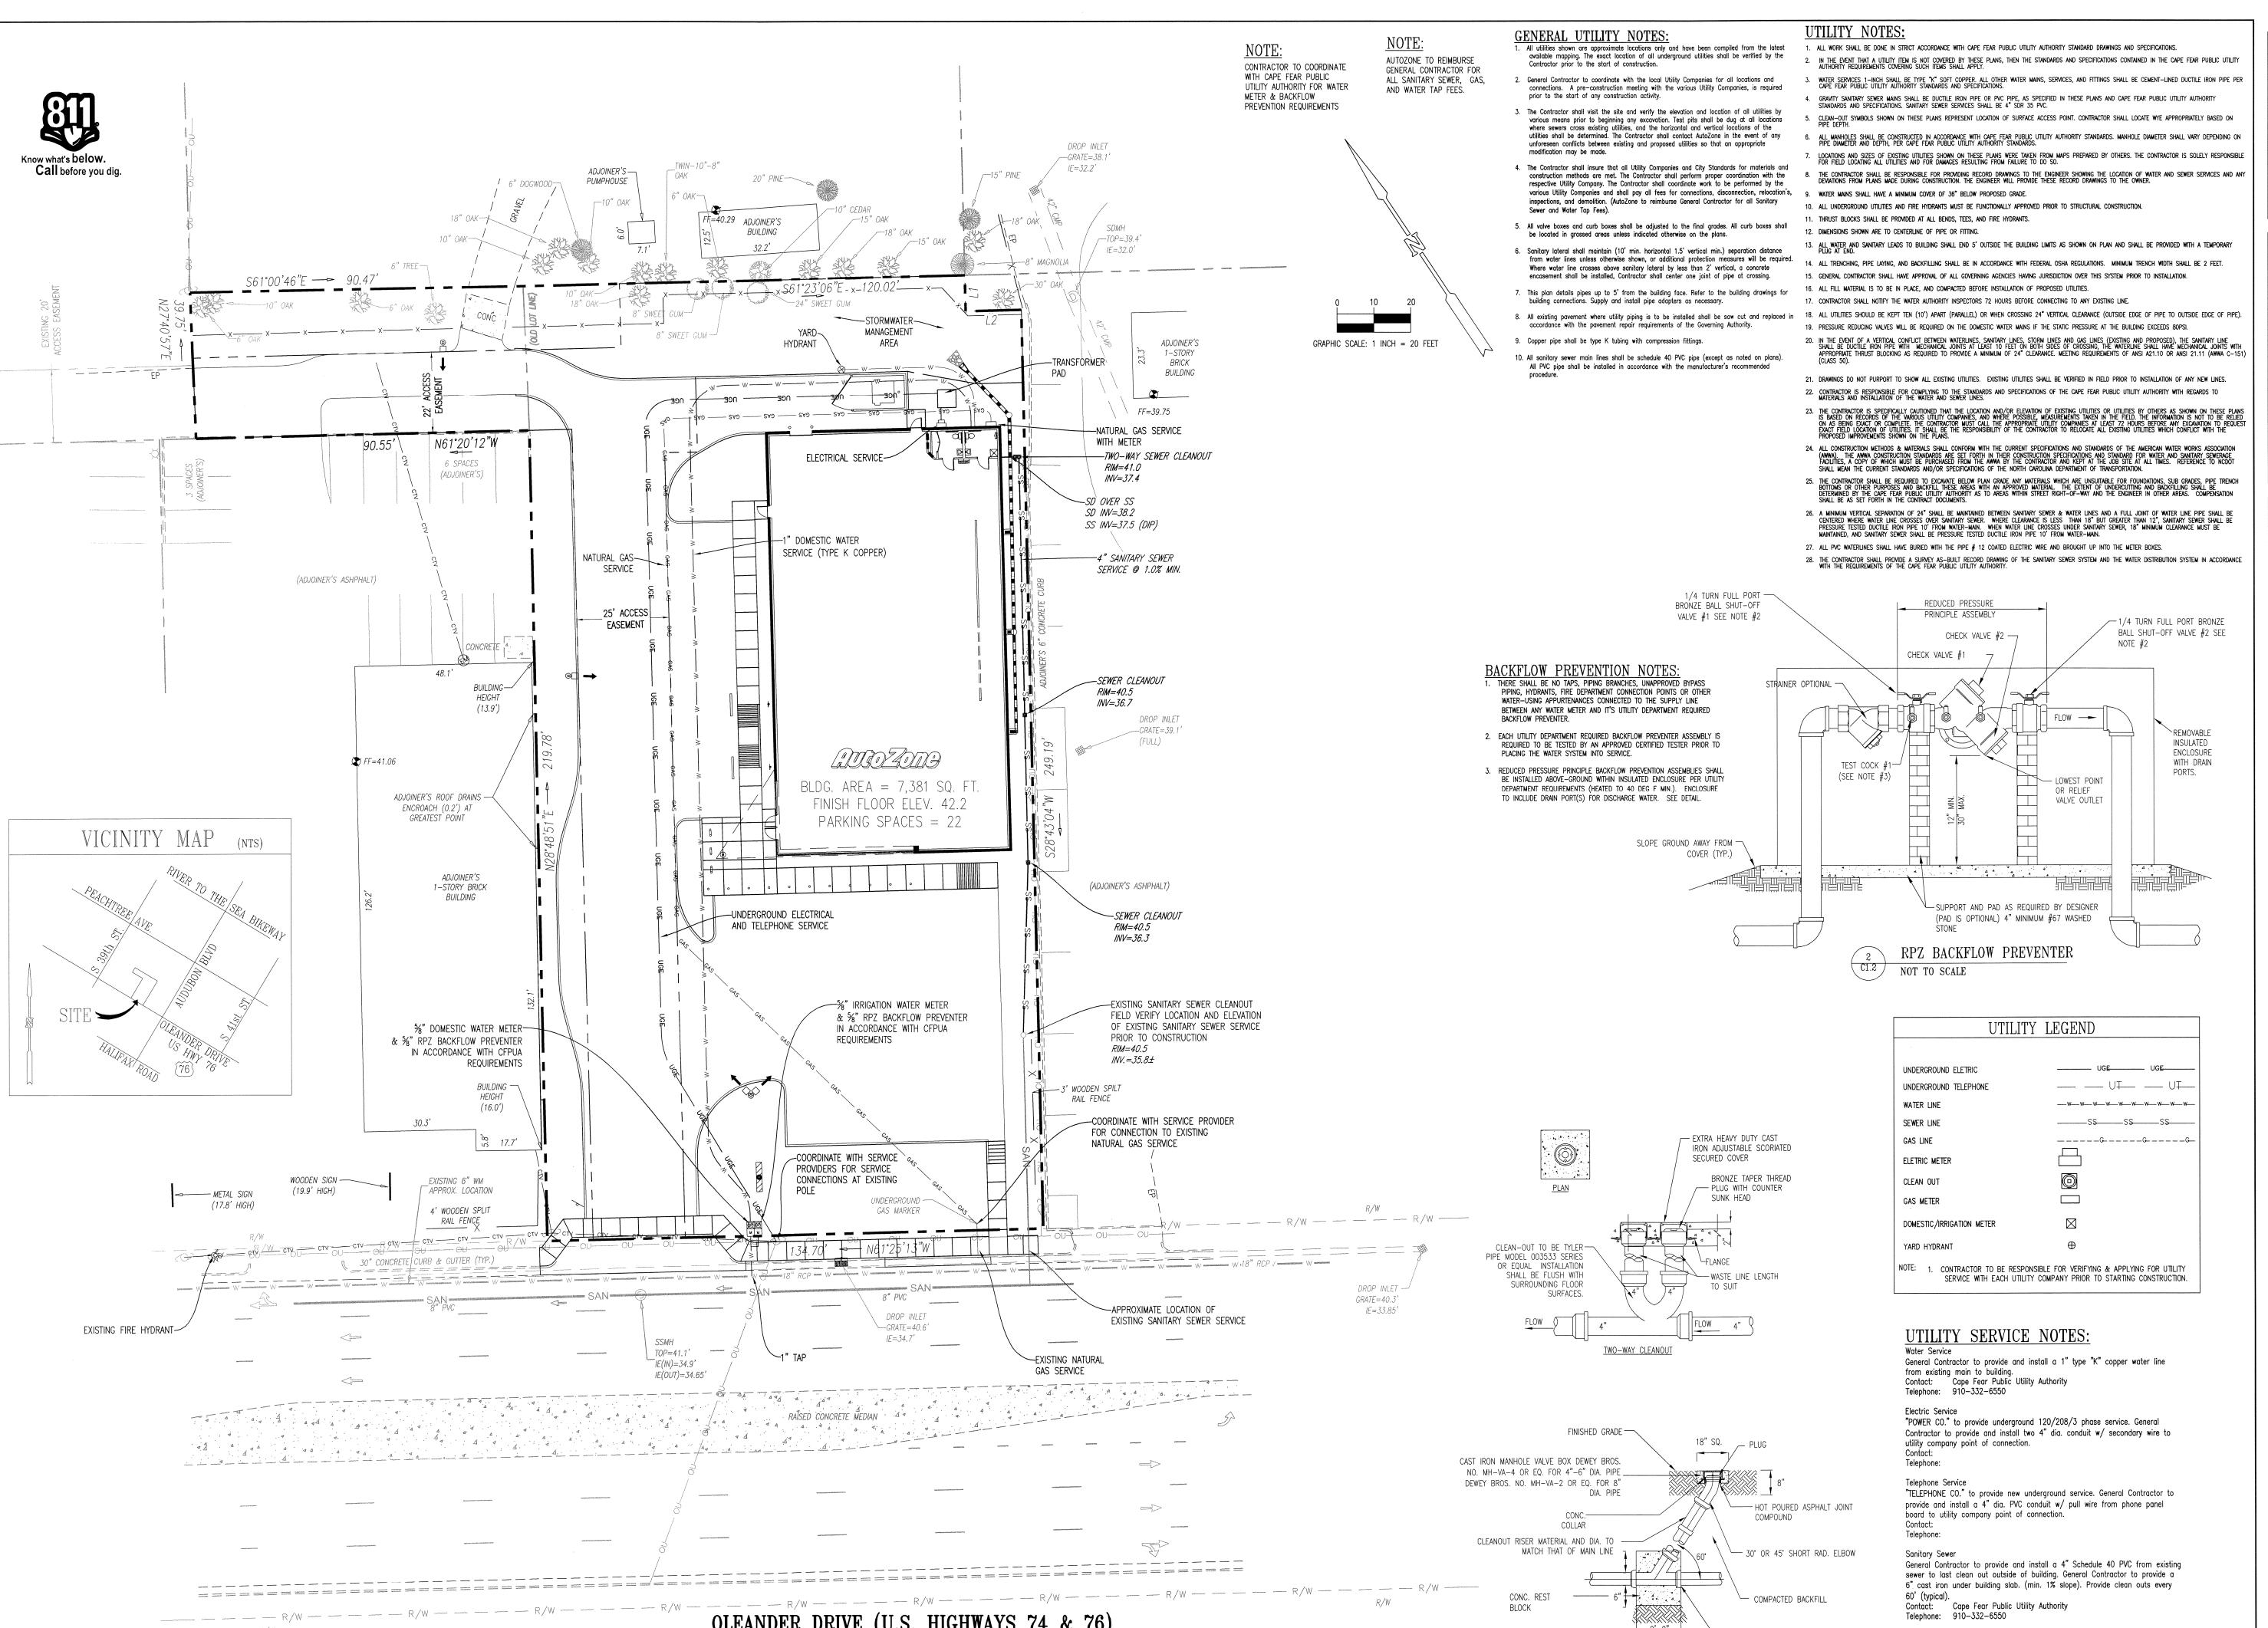
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LAYOUT COORD:	MEL
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DATE:	SEPTEMBER 29, 2015
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TITLE:	

GRADING AND

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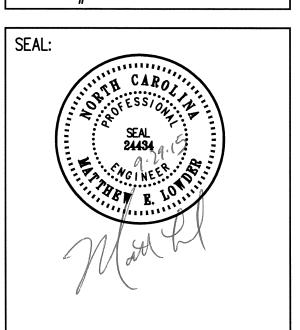


OLEANDER DRIVE (U.S. HIGHWAYS 74 & 76)

(100' PUBLIC R/W)

SITE DESIGN

TRIANGLE SITE DESIGN, PLLC 4006 BARRETT DR, STE 203 RALEIGH, NC 27609 (919) 553-6570 LICENSE #P-0619



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REVISIONS:

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UTILITY PLAN

SHEET NUMBER:

6" cast iron under building slab. (min. 1% slope). Provide clean outs every

"GAS CO." to provide new gas line from existing connection to gas meter.

Contact: Cape Fear Public Utility Authority
Telephone: 910–332–6550

60' (typical).


- COMPACTED BACKFILL


— IF CLEANOUT @ END OF LINE, INSTALL

PLUG HERE

CONC. REST

SANITARY SEWER CLEANOUT

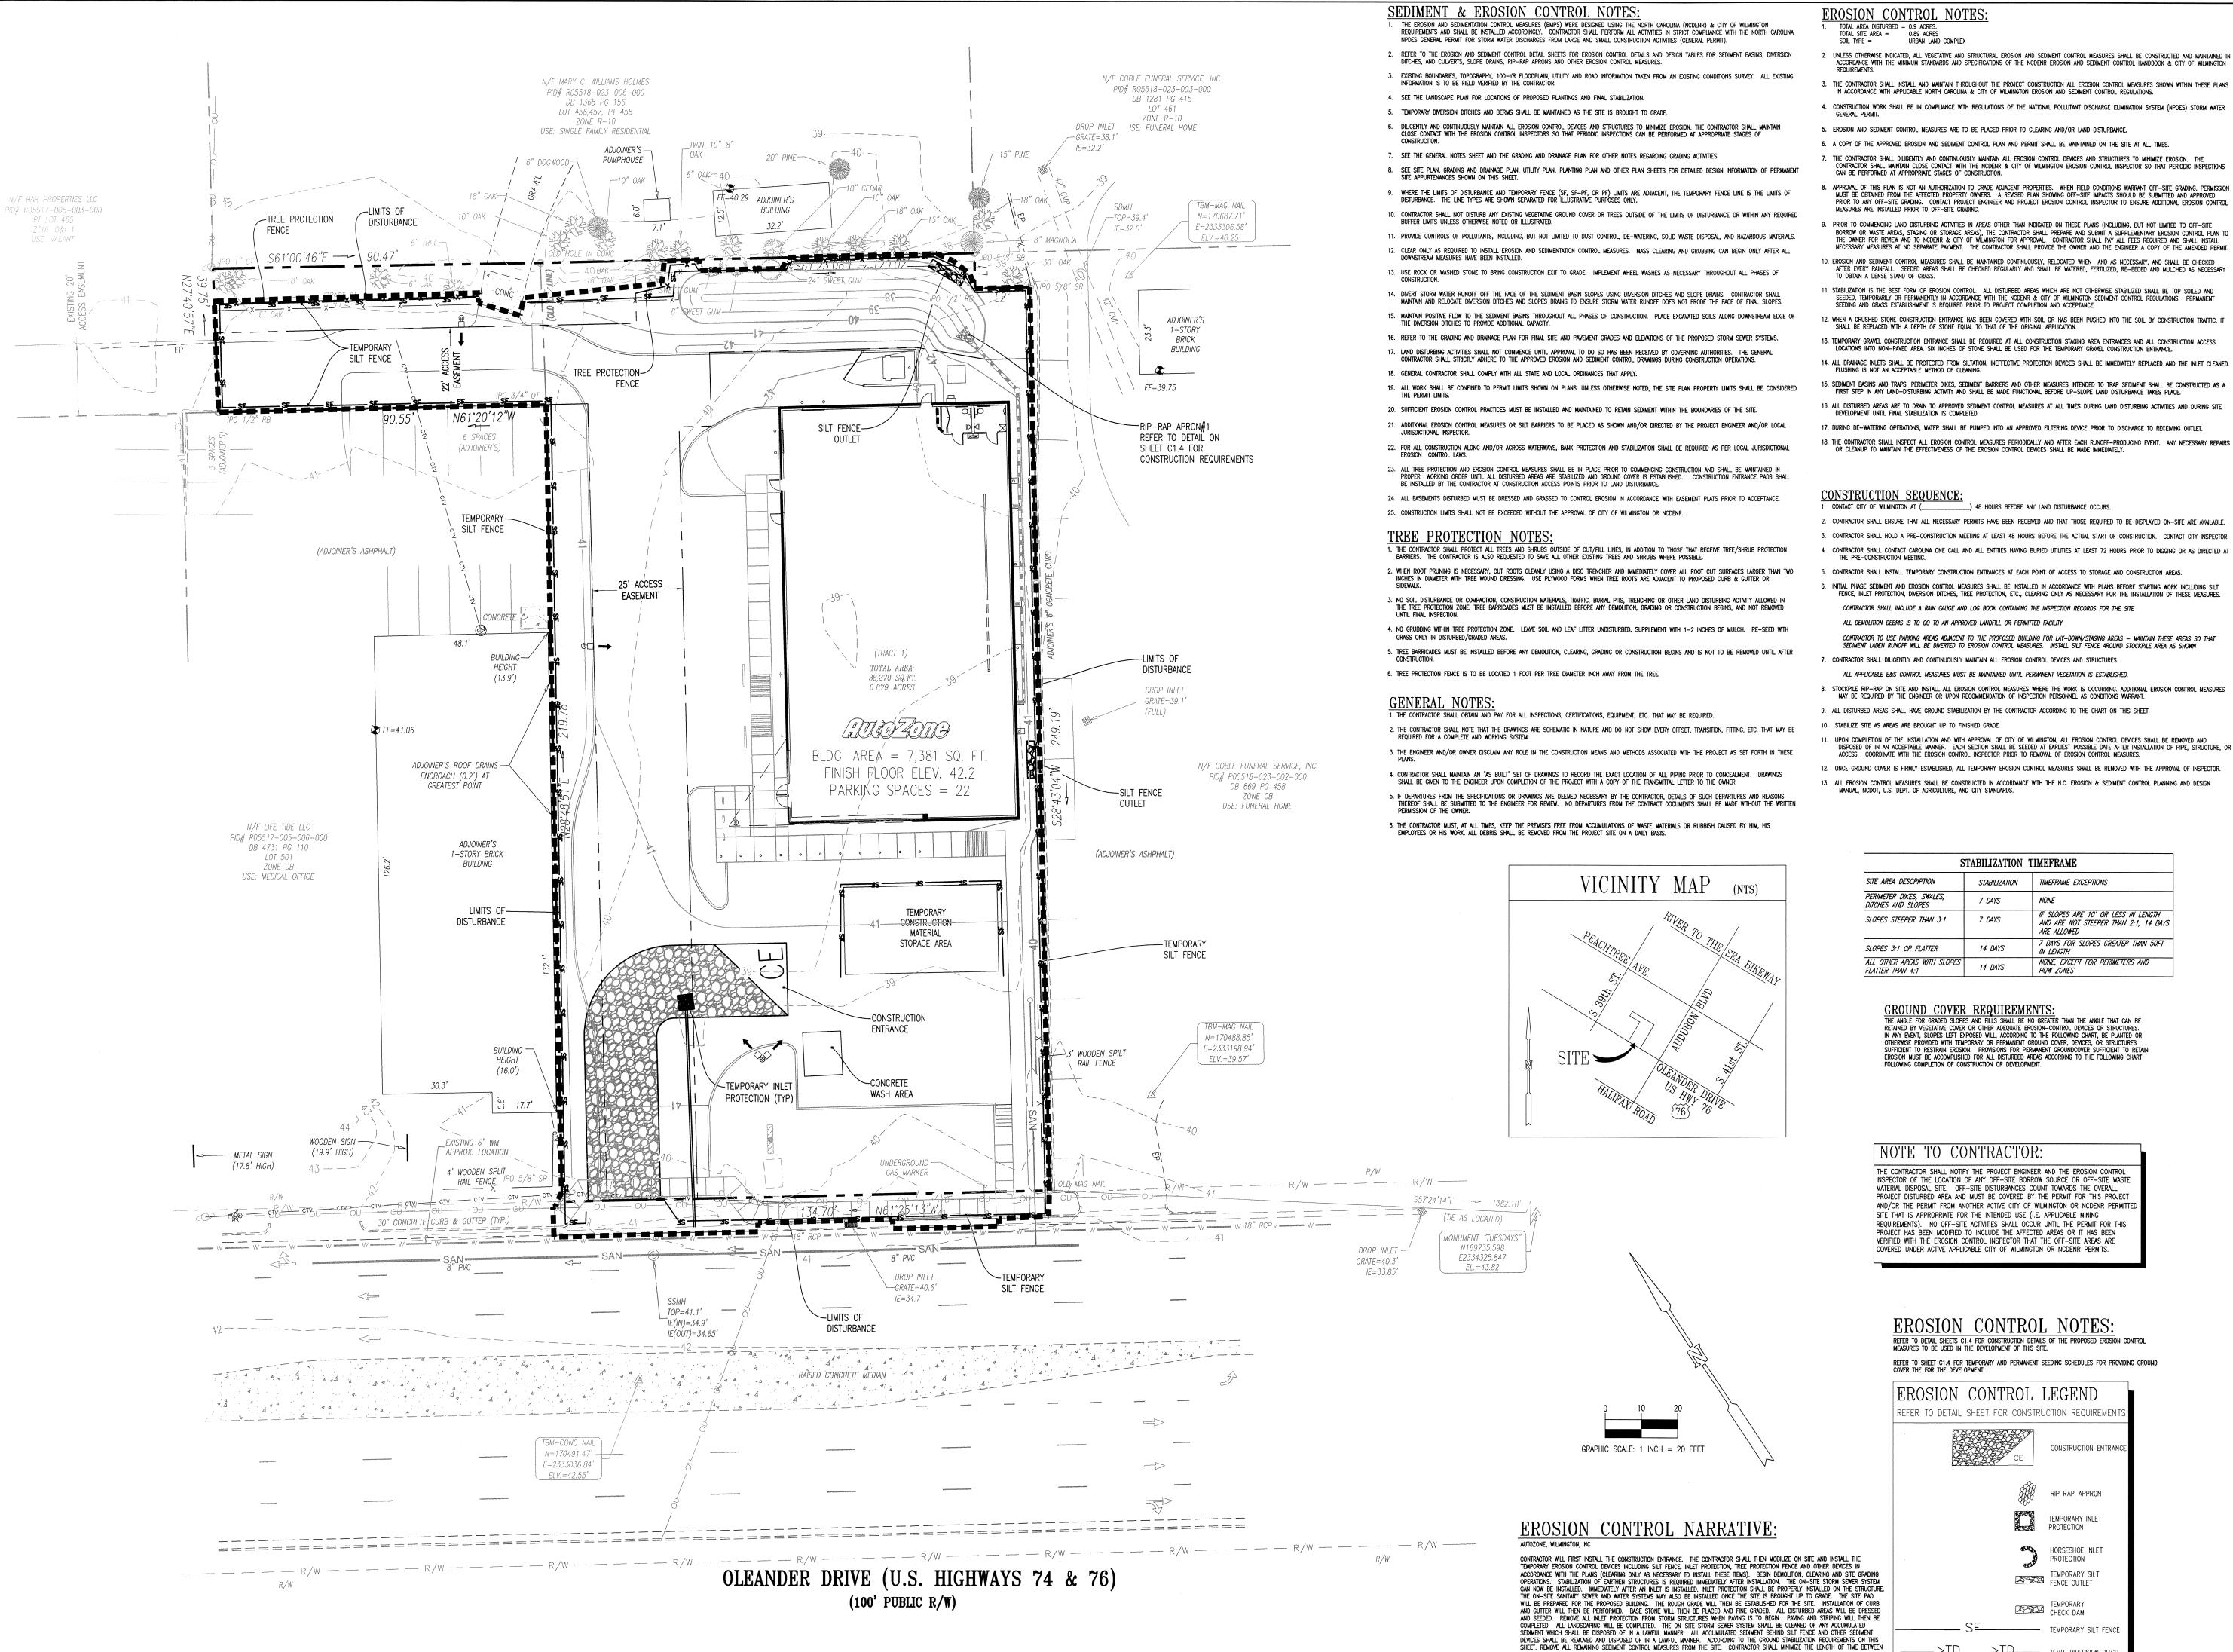

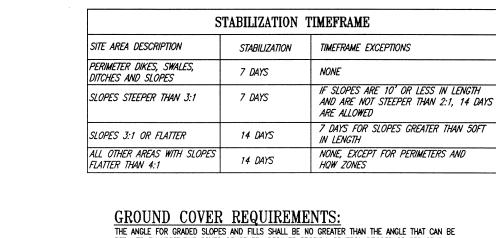

SOIL TYPE =

THE PRE-CONSTRUCTION MEETING.

URBAN LAND COMPLEX

UNLESS OTHERWISE INDICATED, ALL VEGETATIVE AND STRUCTURAL EROSION AND SEDIMENT CONTROL MEASURES SHALL BE CONSTRUCTED AND MAINTAINED IN ACCORDANCE WITH THE MINIMUM STANDARDS AND SPECIFICATIONS OF THE NCDENR EROSION AND SEDIMENT CONTROL HANDBOOK & CITY OF WILMINGTON

5. THE CONTRACTOR SHALL INSTALL AND MAINTAIN THROUGHOUT THE PROJECT CONSTRUCTION ALL EROSION CONTROL MEASURES SHOWN WITHIN THESE PLANS IN ACCORDANCE WITH APPLICABLE NORTH CAROLINA & CITY OF WILMINGTON EROSION AND SEDIMENT CONTROL REGULATIONS.

7. THE CONTRACTOR SHALL DILIGENTLY AND CONTINUOUSLY MAINTAIN ALL EROSION CONTROL DEVICES AND STRUCTURES TO MINIMIZE EROSION. THE CONTRACTOR SHALL MAINTAIN CLOSE CONTACT WITH THE NCDENR & CITY OF WILMINGTON EROSION CONTROL INSPECTOR SO THAT PERIODIC INSPECTIONS CAN BE PERFORMED AT APPROPRIATE STAGES OF CONSTRUCTION.

APPROVAL OF THIS PLAN IS NOT AN AUTHORIZATION TO GRADE ADJACENT PROPERTIES. WHEN FIELD CONDITIONS WARRANT OFF—SITE GRADING, PERMISSION MUST BE OBTAINED FROM THE AFFECTED PROPERTY OWNERS. A REVISED PLAN SHOWING OFF—SITE IMPACTS SHOULD BE SUBMITTED AND APPROVED

PRIOR TO ANY OFF-SITE GRADING. CONTACT PROJECT ENGINEER AND PROJECT EROSION CONTROL INSPECTOR TO ENSURE ADDITIONAL EROSION CONTROL MEASURES ARE INSTALLED PRIOR TO OFF-SITE GRADING.

BORROW OR WASTE AREAS, STAGING OR STORAGE AREAS), THE CONTRACTOR SHALL PREPARE AND SUBMIT A SUPPLEMENTARY EROSION CONTROL PLAN TO THE OWNER FOR REVIEW AND TO NODENR & CITY OF WILMINGTON FOR APPROVAL. CONTRACTOR SHALL PAY ALL FEES REQUIRED AND SHALL INSTALL

NECESSARY MEASURES AT NO SEPARATE PAYMENT. THE CONTRACTOR SHALL PROVIDE THE OWNER AND THE ENGINEER A COPY OF THE AMENDED PERMIT.

SEEDED, TEMPORARILY OR PERMANENTLY IN ACCORDANCE WITH THE NODENR & CITY OF WILLHINGTON SEDIMENT CONTROL REGULATIONS. PERMANENT SEEDING AND GRASS ESTABLISHMENT IS REQUIRED PRIOR TO PROJECT COMPLETION AND ACCEPTANCE.

______) 48 HOURS BEFORE ANY LAND DISTURBANCE OCCURS.

CONTRACTOR TO USE PARKING AREAS ADJACENT TO THE PROPOSED BUILDING FOR LAY-DOWN/STAGING AREAS - MAINTAIN THESE AREAS SO THAT SEDIMENT LADEN RUNOFF WILL BE DIVERTED TO EROSION CONTROL MEASURES. INSTALL SILT FENCE AROUND STOCKPILE AREA AS SHOWN

UPON COMPLETION OF THE INSTALLATION AND WITH APPROVAL OF CITY OF WILMINGTON, ALL EROSION CONTROL DEVICES SHALL BE REMOVED AND
DISPOSED OF IN AN ACCEPTABLE MANNER. EACH SECTION SHALL BE SEEDED AT EARLIEST POSSIBLE DATE AFTER INSTALLATION OF PIPE, STRUCTURE, OR
ACCESS. COORDINATE WITH THE EROSION CONTROL INSPECTOR PRIOR TO REMOVAL OF EROSION CONTROL MEASURES.

CONTRACTOR SHALL INCLUDE A RAIN GAUGE AND LOG BOOK CONTAINING THE INSPECTION RECORDS FOR THE SITE

ALL APPLICABLE E&S CONTROL MEASURES MUST BE MAINTAINED UNTIL PERMANENT VEGETATION IS ESTABLISHED.

MAY BE REQUIRED BY THE ENGINEER OR UPON RECOMMENDATION OF INSPECTION PERSONNEL AS CONDITIONS WARRANT.

ALL DEMOLITION DEBRIS IS TO GO TO AN APPROVED LANDFILL OR PERMITTED FACILITY


RETAINED BY VEGETATIVE COVER OR OTHER ADEQUATE EROSION—CONTROL DEVICES OR STRUCTURES.

IN ANY EVENT, SLOPES LEFT EXPOSED WILL, ACCORDING TO THE FOLLOWING CHART, BE PLANTED OR OTHERWISE PROVIDED WITH TEMPORARY OR PERMANENT GROUND COVER, DEVICES, OR STRUCTURES SUFFICIENT TO RESTRAIN EROSION. PROVISIONS FOR PERMANENT GROUNDCOVER, SUFFICIENT TO RETAIN EROSION. PROVISIONS FOR PERMANENT GROUNDCOVER SUFFICIENT TO RETAIN EROSION MUST BE ACCOMPLISHED FOR ALL DISTURBED AREAS ACCORDING TO THE FOLLOWING CHART FOLLOWING COMPLETION OF CONSTRUCTION OR DEVELOPMENT.

NOTE TO CONTRACTOR:

THE CONTRACTOR SHALL NOTIFY THE PROJECT ENGINEER AND THE EROSION CONTROL INSPECTOR OF THE LOCATION OF ANY OFF-SITE BORROW SOURCE OR OFF-SITE WASTE MATERIAL DISPOSAL SITE. OFF-SITE DISTURBANCES COUNT TOWARDS THE OVERALL PROJECT DISTURBED AREA AND MUST BE COVERED BY THE PERMIT FOR THIS PROJEC' AND/OR THE PERMIT FROM ANOTHER ACTIVE CITY OF WILMINGTON OR NCDENR PERMITTE SITE THAT IS APPROPRIATE FOR THE INTENDED USE (I.E. APPLICABLE MINING REQUIREMENTS). NO OFF-SITE ACTIVITIES SHALL OCCUR UNTIL THE PERMIT FOR THIS PROJECT HAS BEEN MODIFIED TO INCLUDE THE AFFECTED AREAS OR IT HAS BEEN VERIFIED WITH THE EROSION CONTROL INSPECTOR THAT THE OFF-SITE AREAS ARE COVERED UNDER ACTIVE APPLICABLE CITY OF WILMINGTON OR NCDENR PERMITS.

REFER TO SHEET C1.4 FOR TEMPORARY AND PERMANENT SEEDING SCHEDULES FOR PROVIDING GROUND COVER THE FOR THE DEVELOPMENT.

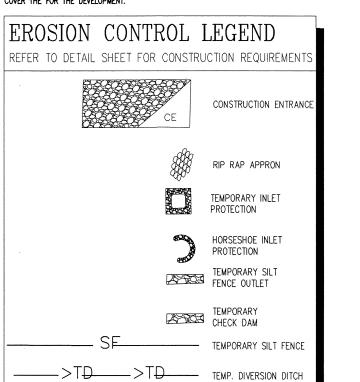


INITIAL LAND DISTURBANCE AND FINAL VEGETATION STABILIZATION OF THE SITE.

THE PROPOSED EROSION AND SEDIMENT CONTROL MEASURES ARE INTENDED TO TRAP ANY STORMWATER RUNOFF FROM THE CONSTRUCTION SITE AND DETAIN IT LONG ENOUGH FOR SEDIMENT AND POLLUTANTS TO SETTLE OUT OF THE STORMWATER BEFORE DISCHARGE. VARIOUS EROSION CONTROL MEASURES ARE USED TO PREVENT POLLUTANT-LADEN STORMWATER RUNOFF FROM FLOWING ONTO ADJACENT PROPERTIES.



CONSULTANT: TRIANGLE SITE DESIGN, PLLC 4006 BARRETT DR, STE 203 RALEIGH, NC 27609 (919) 553–6570

LICENSE #P-0619

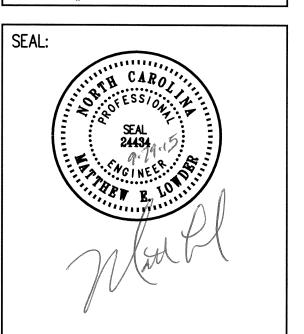

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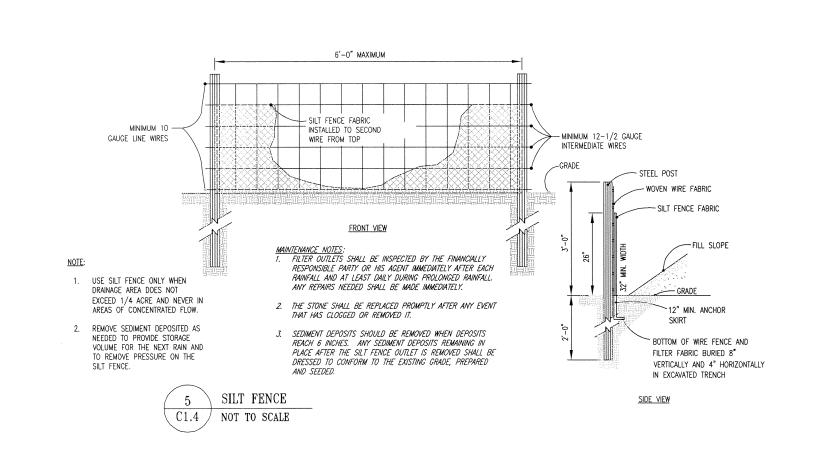
OWNER/DEVELOPER: AUTOZONE DEVELOPMENT, LLC ATTN. WADE DAVIS 123 S. FRONT STREET 3RD FLOOR MEMPHIS, TN 38103-2107 PHONE: (901) 495-8701 FAX: (901) 495-8969 wade.davis@autozone.com For Bidding & Contractor Information Contact: F.W. Dodge Plan Room Tel: (615) 884-1017


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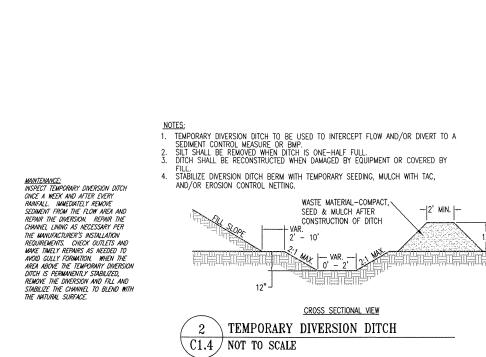
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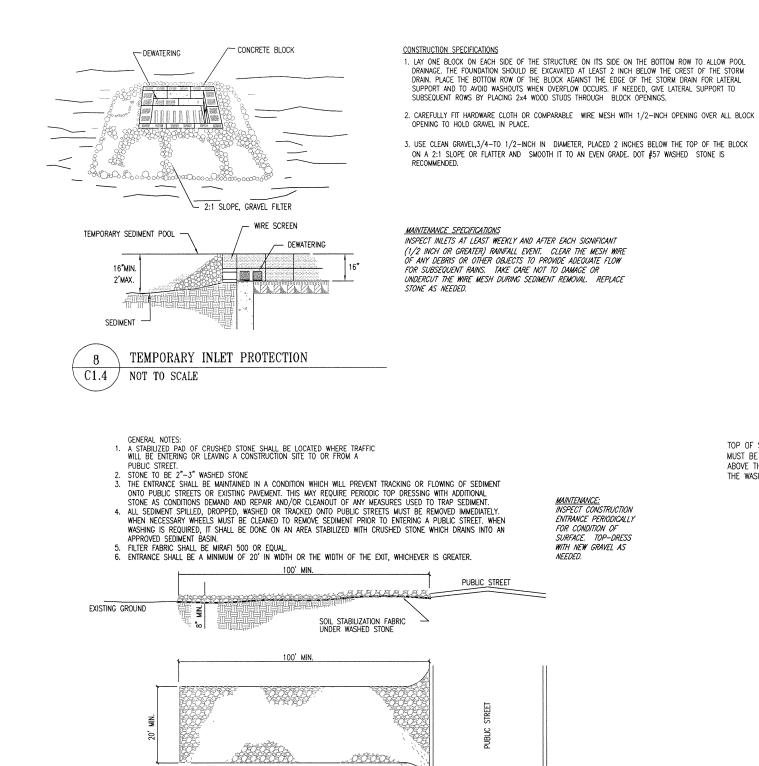
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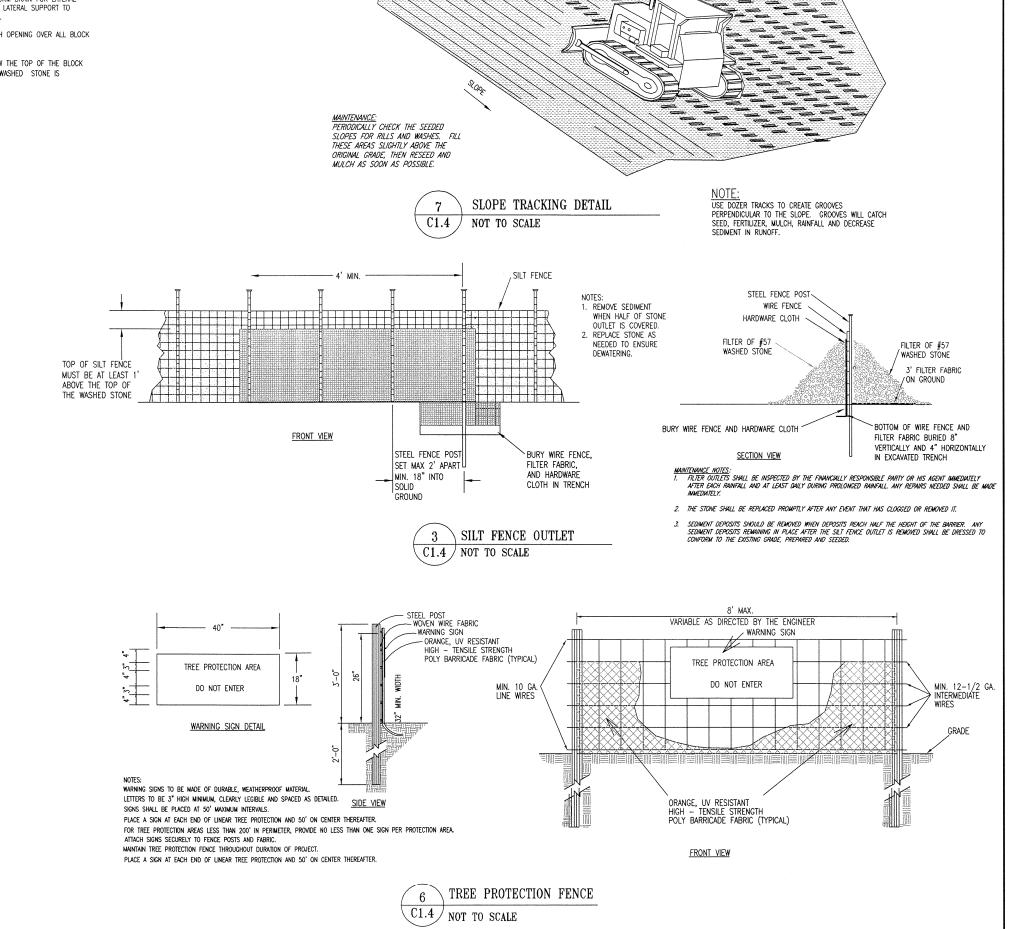








4 \ CONSTRUCTION ENTRANCE


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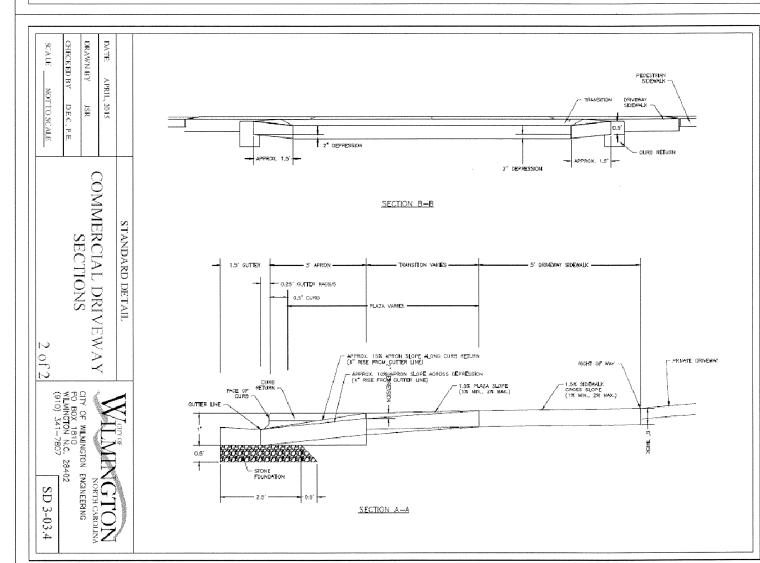


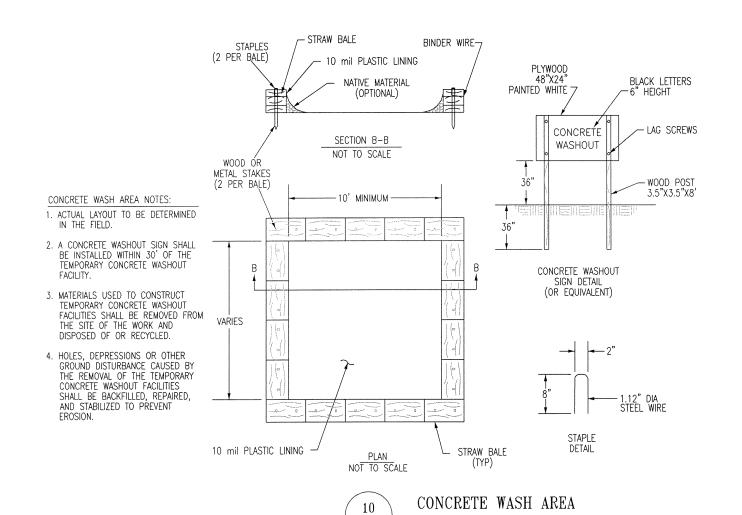


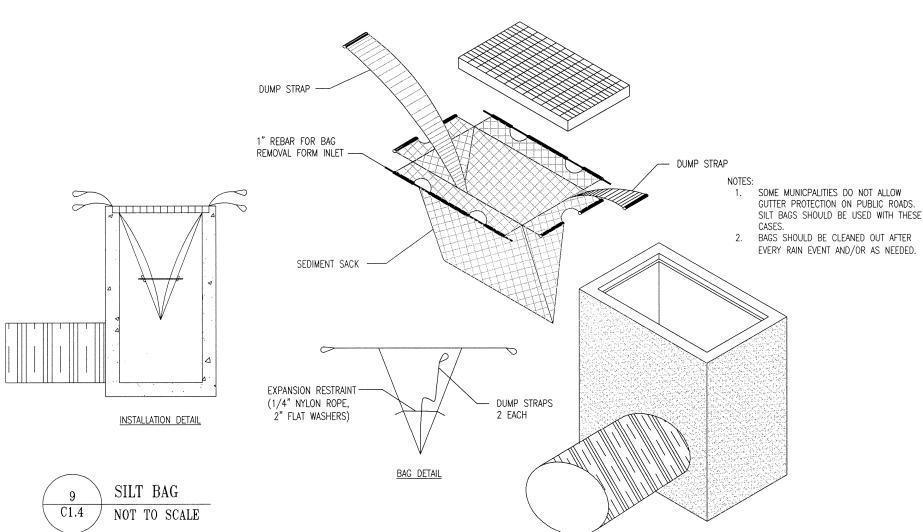NOT TO SCALE



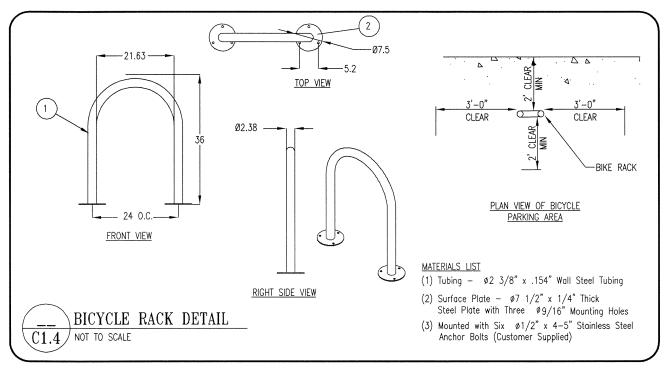

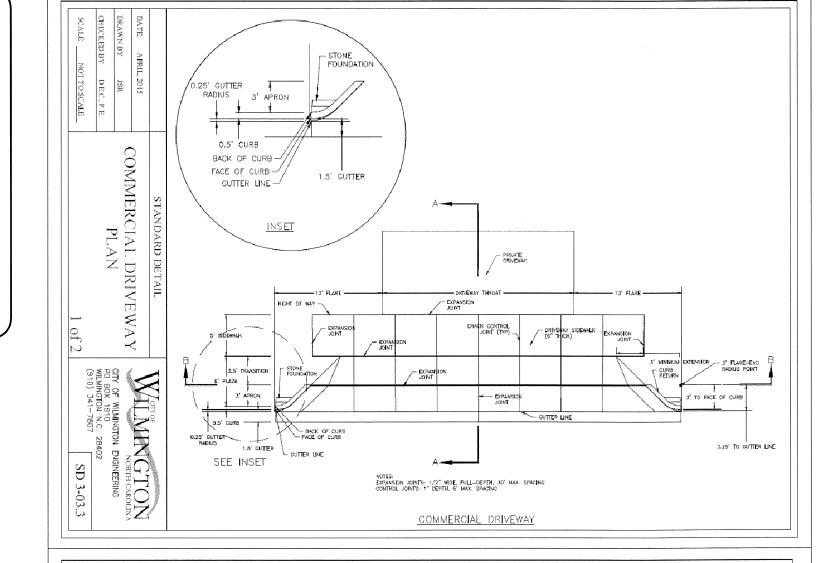

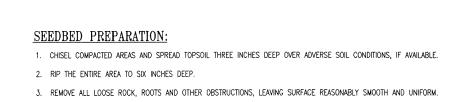

- 4. APPLY AGRICULTURAL LIME, FERTILIZER, AND SUPERPHOSPHATE UNIFORMLY AND MIX WITH SOIL (SEE SEEDING MIXTURE). 5. CONTINUE TILLAGE UNITL A WELL-PULVERIZED, FIRM, REASONABLY UNIFORM SEEDBED IS PREPARED FOUR TO SIX 6. SEED ON A FRESHLY PREPARED SEEDBED AND COVER SEED LIGHTLY WITH SEEDING EQUIPMENT OR CULTIPACK AFTER SEEDING.
- 7. MULCH IMMEDIATELY AFTER SEEDING AND ANCHOR MULCH.
- INSPECT ALL SEEDED AREAS AND MAKE NECESSARY REPAIRS OR RESEEDINGS WITHIN THE PLANTING SEASON, IF POSSIBLE. IF STAND SHOULD BE MORE THAN 60% DAMAGED, RE-ESTABLISH FOLLOWING THE ORIGINAL LIME, FERTILIZER AND SEEDING RATES. 9. CONSULT S&EC ENVIRONMENTAL ENGINEERS ON MAINTENANCE TREATMENT AND FERTILIZATION AFTER PERMANENT COVER IS ESTABLISHED.

SEEDING MIXTURE:

2 TONS/ACRE (3 TONS/ACRE IN CLAY SOILS) AGRICULTURE LIMESTONE 1,000 LBS/ACRE - 10-10-10 SUPERPHOSPHATE: 500 LBS/ACRE - 20% ANALYSIS 2 TONS/ACRE - SMALL GRAIN STRAW ASPHALT EMULSION AT 400 GALS/ACRE

TEMPORARY SEEDING SPECIFICATIONS/SCHEDULE Planting Rate March - Oct. Browntop Millet 40 lbs/acre Nov. – Feb. Winter Rye 120 lbs/acre

SEEDING SPECIFICATIONS/SCHEDUL FOR SHOULDERS, SIDE DITCHES, SLOPES (MAX 3:1) Planting Rate Aug 15 - Nov 1 Tall Fescue 300 lbs/acre Nov 1 - Mar 1 Tall Fescue & Abruzzi Rye 300 lbs/acre Mar 1 - Apr 15 Tall Fescue 300 lbs/acre Apr 14 - Jun 30 Hulled Common Bermuda Grass 25 lbs/acre Jul 1 - Aug 15 Tall Fescue & Browntop Millet 240 lbs/acre-Tall Fescue; or Sorghum-Sudan Hybrids 35 lbs/acre Browntop Millet 30 lbs/acre Sorghum-Sudan


FOR SHOULDERS, SIDE DITCHES, SLOPES (3:1 - 2:1) Туре Planting Rate Mar 1 — Jun 1 Sericea Lespedeza (scarified) & 50 lbs/acre (Serica Lespedeza) use the following combinations: Mar 1 - Apr 15 Add Tall Fescue 240 lbs/acre Mar 1 - Jun 30 Or add Julled Common 25 lbs/acre Bermuda Grass

240 lbs/acre Tall Fescue Jun 1 - Sep 1 Tall Fescue & Browntop Millet or Sorghum—Sudan Hybrids 35 lbs/acre Browntop Millet 30 lbs/acre Sorghum-Sudan 70 lbs/acre Sericea Lespedeza Sep 1 - Mar 1 Sericea Lespedeza (Unhulled-Unscarafied & Tall Fescue 240 lbs/acre Tall Fescue Nov 1 — Mar 1 Add Abruzzi Rye 25 lbs/acre

CONSULT S&EC ENGINEER FOR ADDITIONAL INFORMATION CONCERNING OTHER ALTERNATIVES FOR VEGETATION OF DENUDED AREAS. THE ABOVE VEGETATION RATES ARE THOSE THAT DO WELL UNDER LOCAL CONDITIONS; OTHER SEEDING RATE COMBINATIONS ARE POSSIBLE. *** TEMPORARY: RESEED ACCORDING TO OPTIMUM SEASON FOR DESIRED PERMANENT VEGETATION. DO NOT ALLOW TEMPORARY COVER TO GROW MORE THAN 12" IN HEIGHT BEFORE MOWING; OTHERWISE, FESCUE MAY BE SHADED OUT.




CONSULTANT: TRIANGLE SITE DESIGN, PLLC 4006 BARRETT DR, STE 203 RALEIGH, NC 27609 (919) 553-6570 LICENSE #P-0619

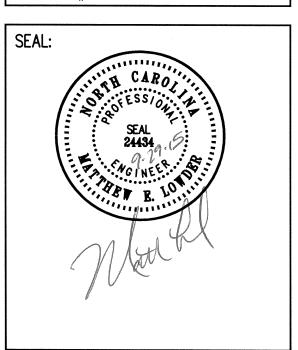

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OWNER/DEVELOPER: AUTOZONE DEVELOPMENT, LLC ATTN. WADE DAVIS 123 S. FRONT STREET 3RD FLOOR MEMPHIS, TN 38103-2107 PHONE: (901) 495-8701 FAX: (901) 495-8969 wade.davis@autozone.com For Bidding & Contractor Information Contact: F.W. Dodge Plan Room Tel: (615) 884-1017

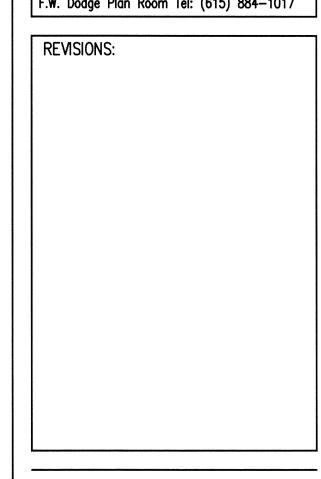



LAYOUT COORD:	MEL
PLANNING MGR.	MEL
DRAWING BY:	MEL
DATE:	SEPTEMBER 29, 2015
JOB NUMBER:	010048
TITLE:	07011071011
CON	STRUCTION

CONSTITUTION **DETAILS**

SHEET NUMBER:

COMMENTS:

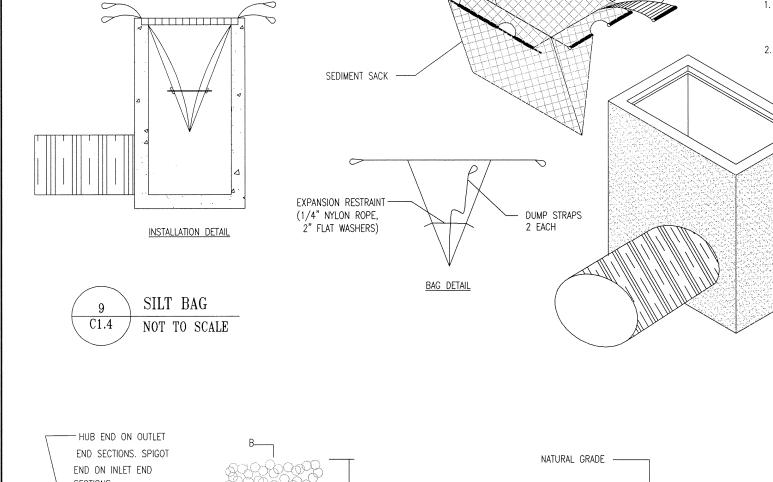

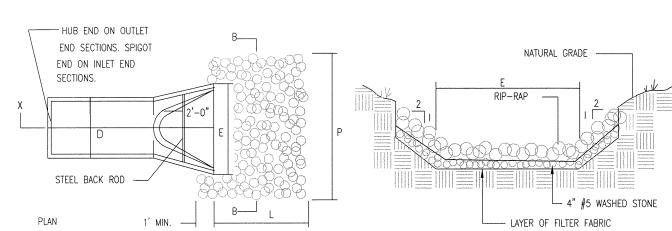

RIPRAP SHOULD EXTEND UP BOTH SIDES OF THE APRON AND AROUND THE END OF THE PIPE OR CULVERT AT THE DISCHARGE OUTLET AT A MAXIMUM SLOPE OF 2:1 AND A HEIGHT NOT LESS THAN TWO THIRDS THE PIPE DIAMETER OR CULVERT HEIGHT.

THERE SHALL BE NO OVERFLOW FROM THE END OF THE APRON TO THE SURFACE OF THE RECEIVING CHANNEL. THE AREA TO BE PAVED OR RIP-RAPPED SHALL BE UNDERCUT SO THAT THE INVERT OF THE APRON SHALL BE AT THE SAME GRADE (FLUSH) WITH THE SURFACE OF THE RECEIVING CHANNEL. THE APRON SHALL HAVE A CUTOFF OR TOE WALL AT THE DOWNSTREAM END.


MAXIMUM TAPER TO RECEIVING CHANNEL 5:1. THE WIDTH OF THE END OF THE APRON SHALL BE EQUAL TO THE BOTTOM WIDTH OF THE RECEIVING CHANNEL.


ALL SUBGRADE STRUCTURE TO BE COMPACTED TO 95% OR GREATER. THE PLACING OF FILL, EITHER LOOSE OR COMPACTED IN THE RECEIVING CHANNEL SHALL NOT BE ALLOWED.

NO BENDS OR CURVES IN THE HORIZONTAL ALIGNMENT OF THE APRON WILL BE PERMITTED.

RIP-RAP APRON \subset C1.4 \nearrow NOT TO SCALE


<u>VAINTENANCE:</u> INSPECT RIP—RAP APRON AT REGULAR INTERVALS AS WELL AS AFTER MAJOR RAINS, AND MAKE REPAIRS PROMPTLY. GIVE SPECIAL ATTENTION TO THE POINT WHERE CONCENTRATED STORM WATER FROM DRAINAGE PIPE SYSTEMS ENTER THE APRON. CAREFULLY CHECK STABILITY OF RIP-RAP AND LOOK FOR INDICATIONS OF PIPING, SCOUR HOLES, OR BANK FAILURES. MAKE REPAIRS

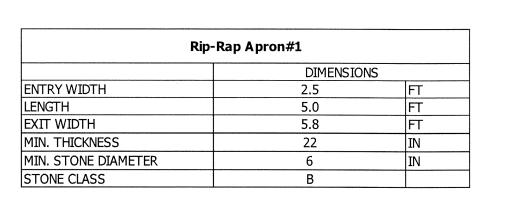

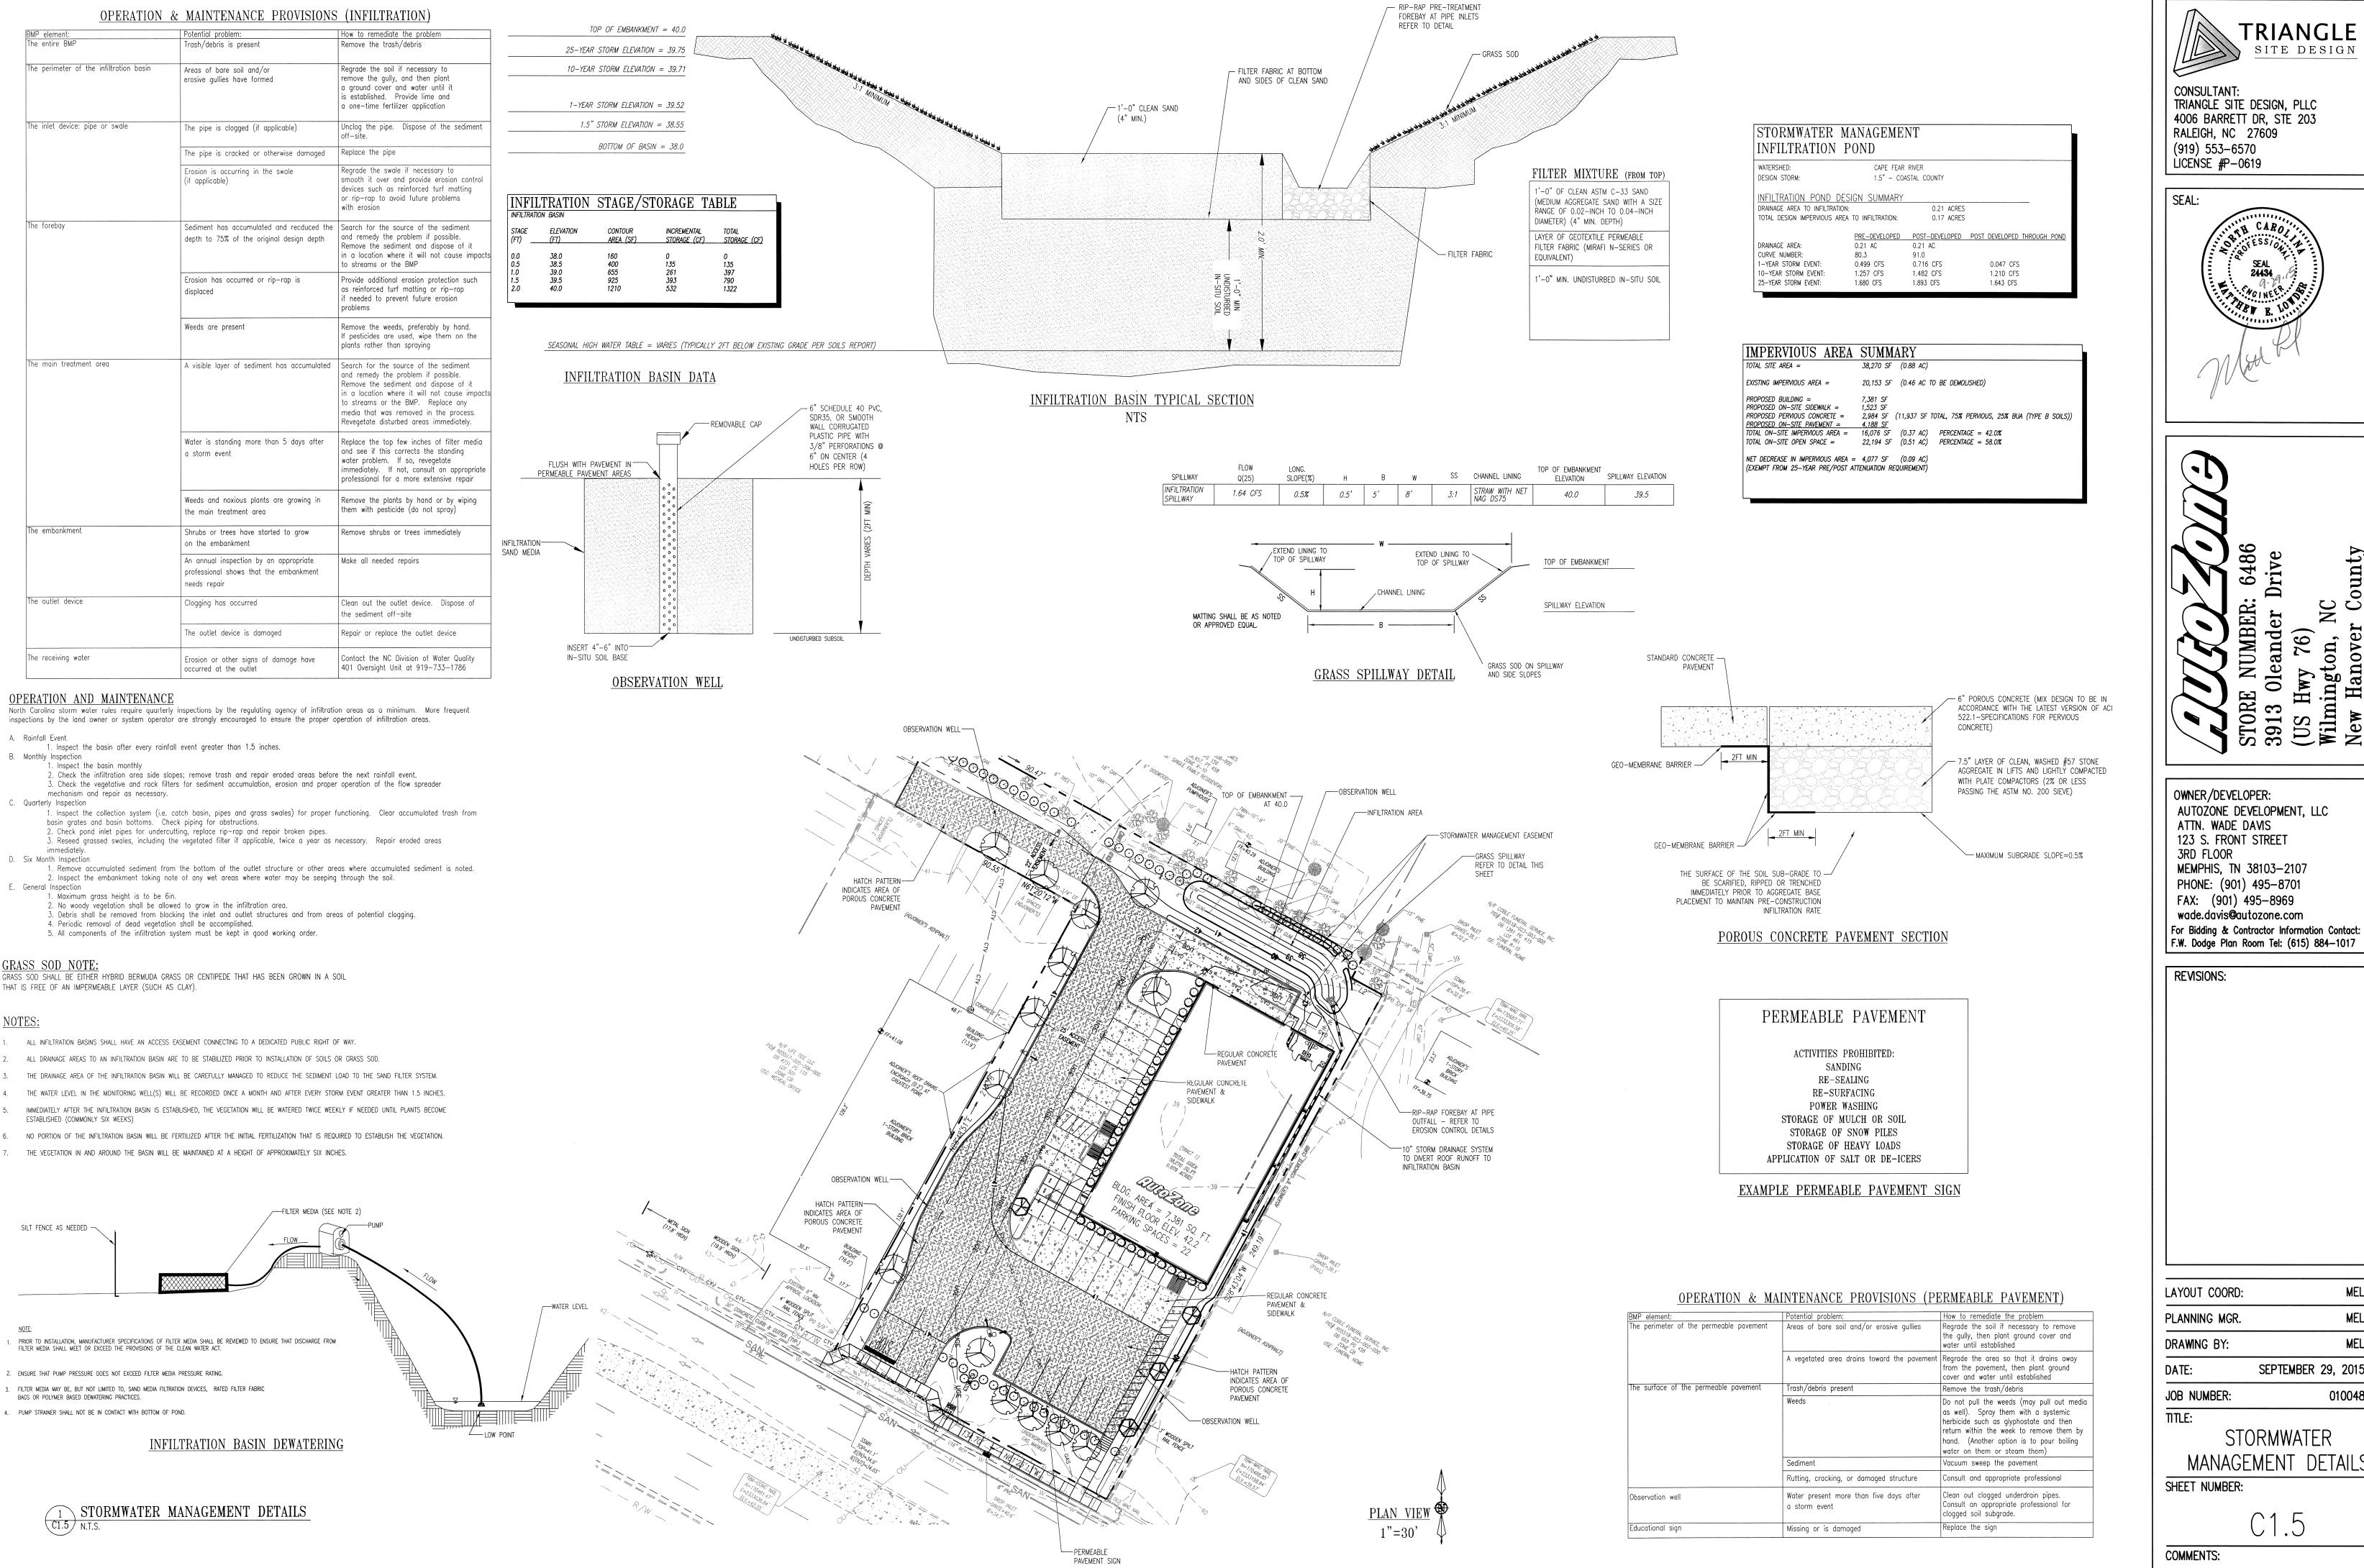



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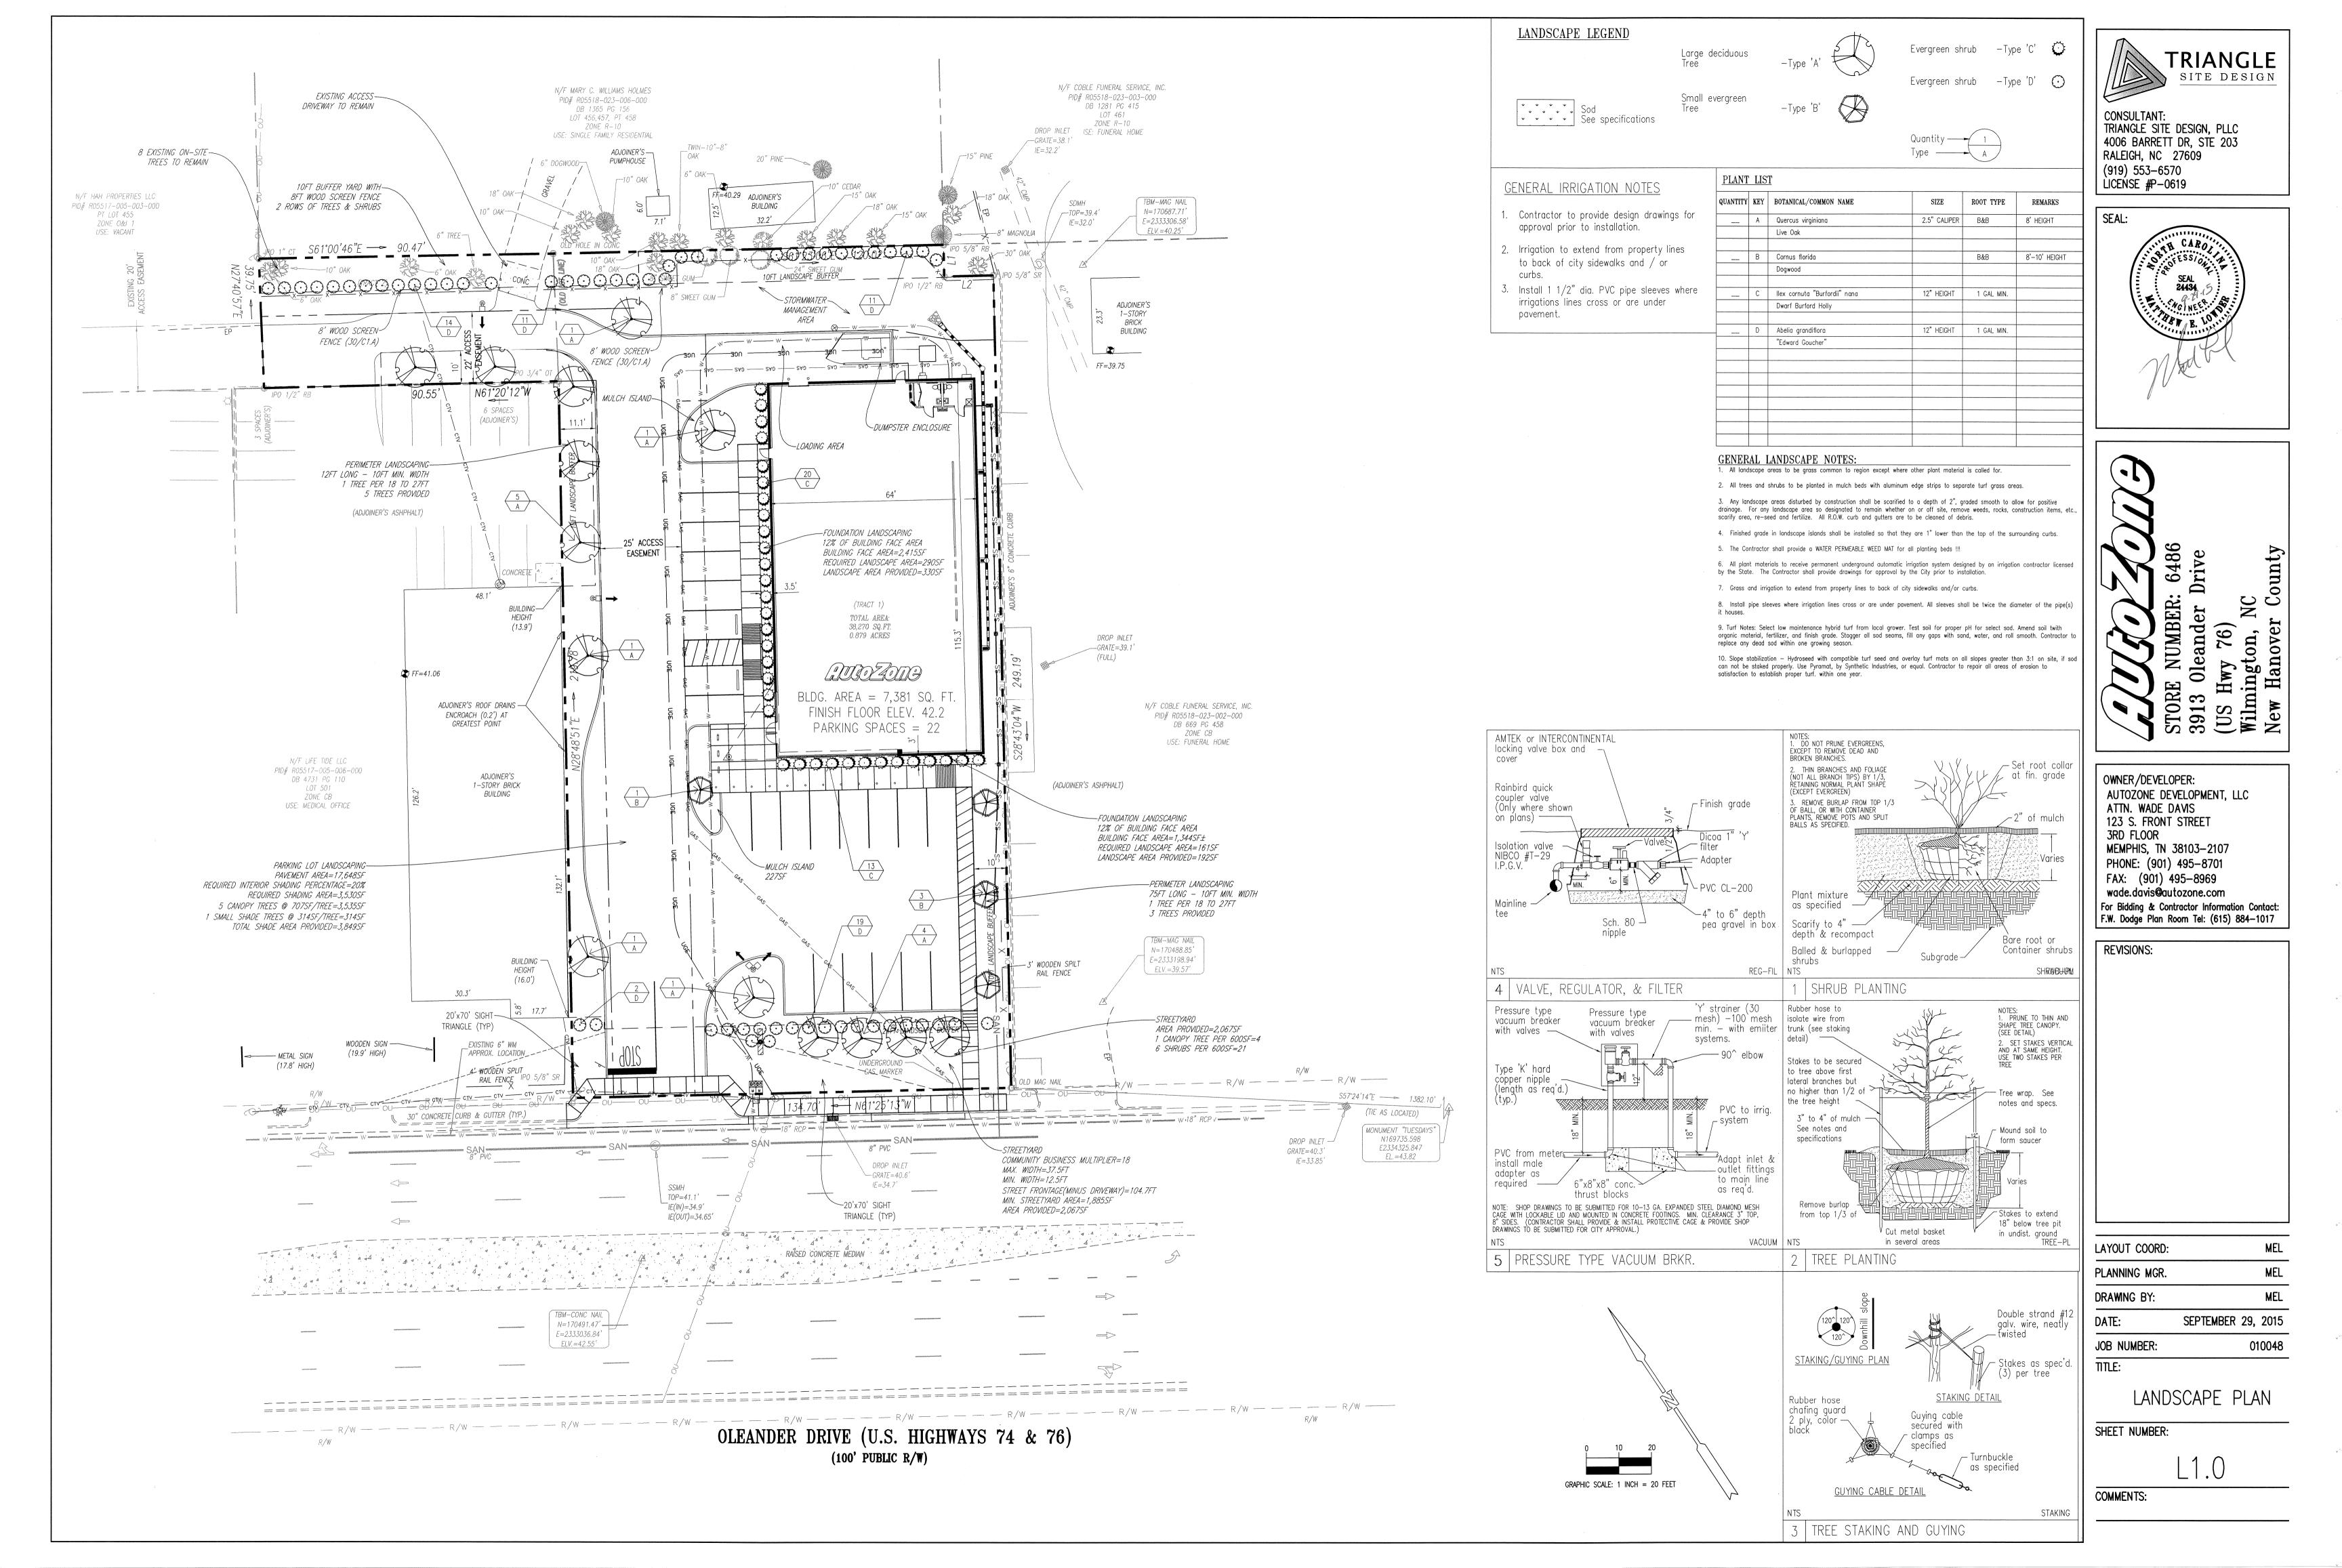
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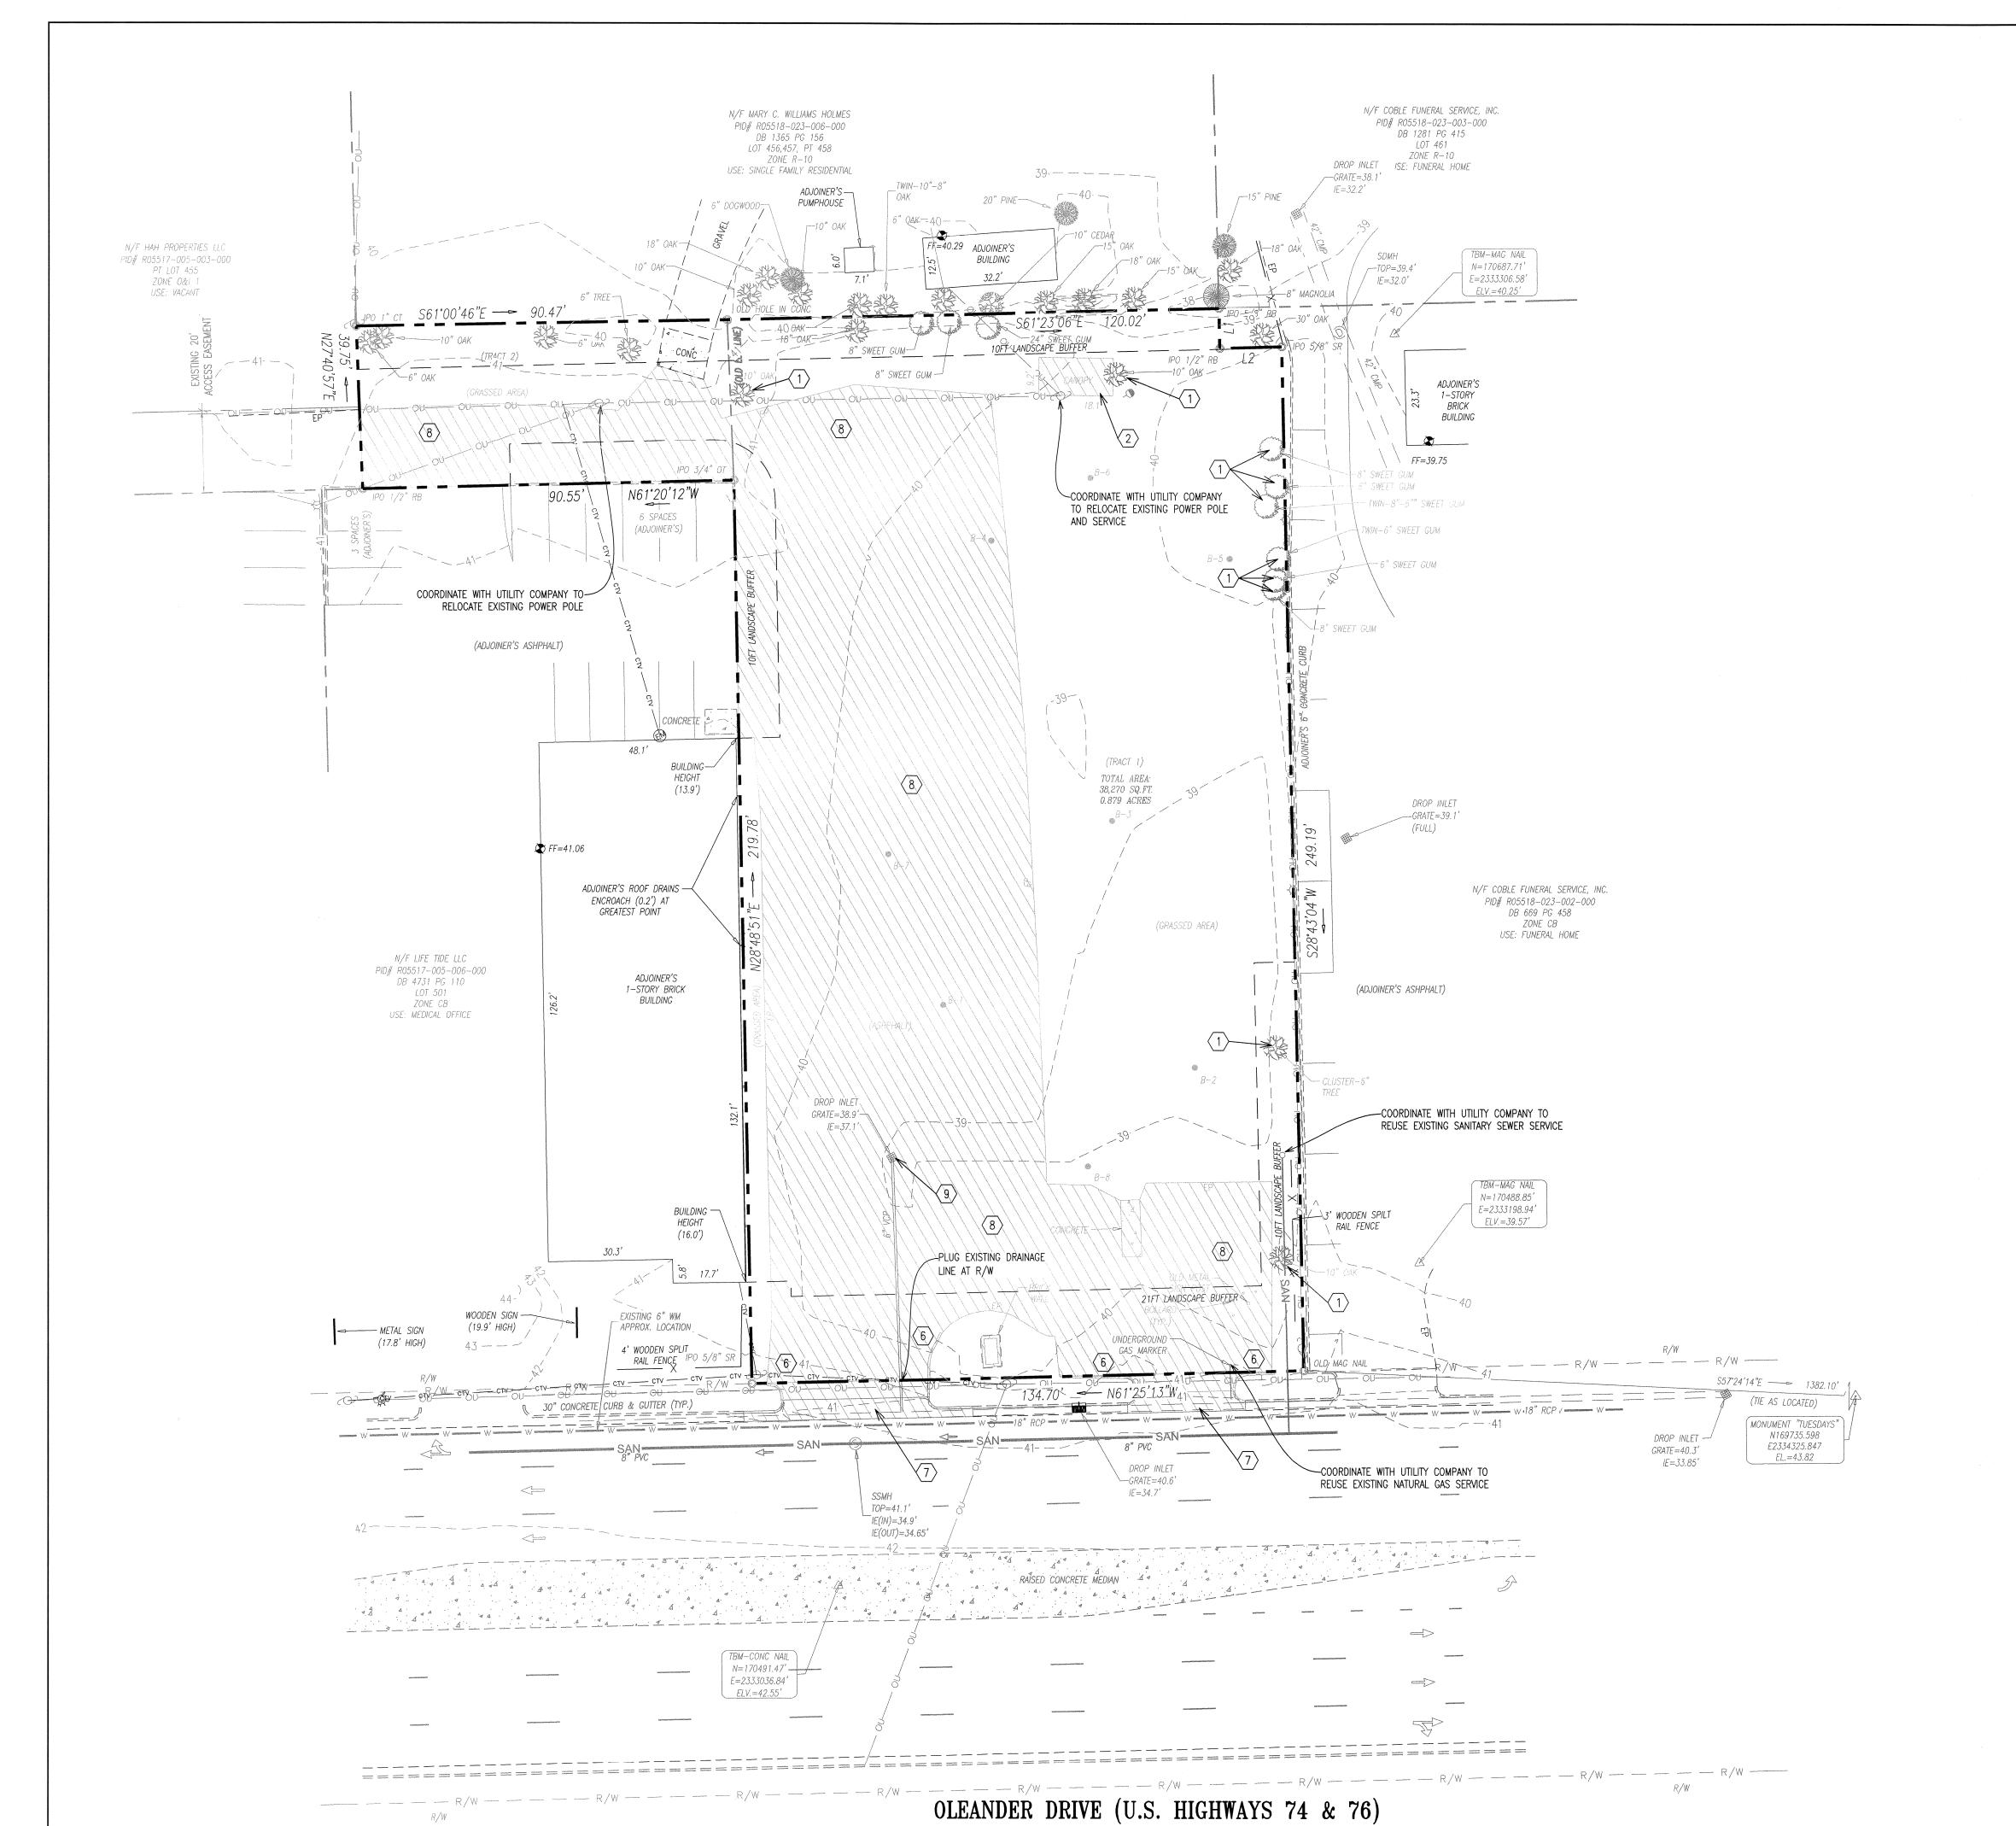
LAYOUT COORD: PLANNING MGR. DRAWING BY: SEPTEMBER 29, 2015 DATE:

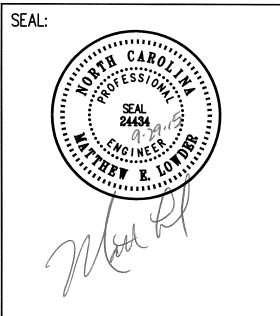TITLE: STORMWATER

SHEET NUMBER:

MANAGEMENT DETAILS






(100' PUBLIC R/W)





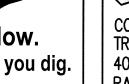


CAUTIONARY NOTE

THE LOCATIONS OF ALL EXISTING UNDERGROUND UTILITIES SHOWN ON THIS DRAWING ARE BASED ON ABOVE GROUND EVIDENCE OR INFORMATION GATHERED DURING THE FIELD SURVEY PORTION OF THIS PROJECT. AS SUCH, THIS INFORMATION IS SPECULATIVE IN NATURE ONLY AND SHOULD NOT BE CONSTRUED AS FACT. THERE MAY ALSO BE OTHER EXISTING UNDERGROUND UTILITIES FOR WHICH NO ABOVE GROUND EVIDENCE WAS OBSERVED. THE EXACT LOCATIONS OF THE UNDERGROUND UTILITIES SHALL BE VERIFIED BY THE CONTRACTOR PRIOR TO THE START OF ANY AND ALL CONSTRUCTION.

UTILITY STATEMENT

THE UNDERGROUND UTILITIES SHOWN HAVE BEEN LOCATED FROM FIELD SURVEY INFORMATION AND EXISTING DRAWINGS. THE SURVEYOR MAKES NO GUARANTEES THAT THE UNDERGROUND UTILITIES COMPRISE ALL SUCH UTILITIES IN THE AREA, EITHER IN-SERVICE OR ABANDONED. THE SURVEYOR FURTHER DOES NOT WARRANT THAT THE UNDERGROUND UTILITIES SHOWN ARE IN THE EXACT LOCATION INDICATED ALTHOUGH THE SURVEYOR DOES CERTIFY THAT THEY ARE LOCATED AS ACCURATELY AS POSSIBLE FROM INFORMATION AVAILABLE. THE SURVEYOR HAS NOT PHYSICALLY LOCATED THE UNDERGROUND UTILITIES.

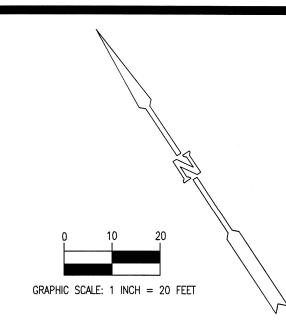

KEYNOTES

DEMOLITION

- (1) Remove trees and root system
- (2) Remove existing building and foundation
- (3) Remove fence, post, and foundation
- 4 Remove all existing shrubs and debris
- 5 Remove existing sidewalks
- (6) Remove existing concrete curb
- 7 Remove existing driveway approaches
- (8) Remove existing pavement
- (9) Remove existing utilities

DEMOLITION NOTES


- GENERAL DEMOLITION NOTES:
- . ALL WORK TO BE ACCOMPLISHED IN STRICT ACCORDANCE WITH ALL LOCAL ORDINANCES, CITY OR STATE. P. WITHIN THE SUBJECT PROPERTY, THE INTENT IS TO HAVE A CLEAN, CLEAR SITE, FREE OF ALL EXISTING ITEMS NOTED TO BE REMOVED IN ORDER TO PERMIT THE CONSTRUCTION OF THE NEW PROJECT.
- ALL ITEMS NOTED TO BE REMOVED BY THE SELLER SHALL BE ACCOMPLISHED PRIOR TO THE CLOSING OF THE REAL ESTATE TRANSACTION. ALL OTHER ITEMS NOTED TO BE REMOVED SHALL BE DONE SO AS PART OF THE CONTRACT FOR GENERAL CONSTRUCTION.
- REMOVE AND DISPOSE OF ANY SIDEWALKS, FENCES, STAIRS, WALLS, DEBRIS AND RUBBISH REQUIRING REMOVAL FROM
- THE WORK AREA IN AN APPROVED OFF SITE LANDFILL. 5. THE CONTRACTOR SHALL SECURE ALL PERMITS FOR HIS DEMOLITION AND DISPOSAL OF HIS DEMOLITION MATERIAL TO BE REMOVED FROM THE SITE. THE CONTRACTOR SHALL POST BONDS AND PAY PERMIT FEES AS REQUIRED.
- BUILDING DEMOLITION CONTRACTOR SHALL BE RESPONSIBLE FOR PERMITS AND DISPOSAL OF BUILDING DEMOLITION
- THE DETAILED PLANS MAY NOT REFLECT ALL UTILITIES ON THE SITE OR SURROUNDING STREETS AND PROPERTIES. THE CONTRACTOR SHALL VERIFY LOCATIONS AND EXISTENCE OF UTILITY SERVICES PRIOR TO CONSTRUCTION. THE CONTRACTOR SHALL CALL "DIG SAFE" AT 1-800-344-7233, 72 HOURS PRIOR TO CONSTRUCTION.
- THE CONTRACTOR TO REMOVE ALL UTILITIES TO EXISTING STRUCTURES WHETHER SHOWN OR NOT OR ARRANGE FOR THE APPROPRIATE UTILITY COMPANY TO CUT AND CAP SERVICE PIPING AT THE PROPERTY LINE OR MAIN (AS REQUIRED). ALL SERVICES MAY NOT BE SHOWN ON THIS PLAN.
- UNDERGROUND ELEMENTS AS WELL INCLUDING BUT NOT NECESSARILY LIMITED TO: FOUNDATIONS, GRAVEL FILLS, TREE ROOTS, OLD PIPES, ETC.

FOR ALL ITEMS NOTED TO BE REMOVED - REMOVE NOT ONLY THE ABOVE GROUND ELEMENTS, BUT ALL

- 10. BACK FILL ALL EXCAVATIONS RESULTING FROM THE DEMOLITION WORK TO MEET THE REQUIREMENTS FOR FILL OUTLINED IN THE GEOTECHNICAL REPORT.
- THE CONTRACTOR SHALL PROTECT ALL IRON PINS, MONUMENTS AND PROPERTY CORNERS DURING CONSTRUCTION. ANY CONTRACTOR DISTURBED PINS, MONUMENTS, ETC. SHALL BE RESET BY A LICENSED LAND SURVEYOR AT THE EXPENSE OF THE CONTRACTOR.
- P. THE CONTRACTOR SHALL RESTORE ANY UTILITY STRUCTURE, PIPES, PAVEMENT, CURBS, SIDEWALKS OR LANDSCAPED AREAS DISTURBED DURING DEMOLITION TO THEIR ORIGINAL CONDITION TO THE SATISFACTION.
- 3. ALL BUILDINGS, FOUNDATION WALLS AND FOOTINGS INDICATED ON THIS PLAN TO BE REMOVED FROM SITE. CONTRACTOR SHALL SECURE ANY PERMITS AND PAY ALL FEES AND PERFORM CLEARING AND GRUBBING AND DEBRIS
- REMOVAL PRIOR TO COMMENCEMENT OF GRADING OPERATIONS.
- 14. ASBESTOS AND ANY OTHER HAZARDOUS MATERIAL SHALL BE REMOVED BY THE GENERAL CONTRACTOR USING A LICENSED HAZARDOUS MATERIAL CONTRACTOR.



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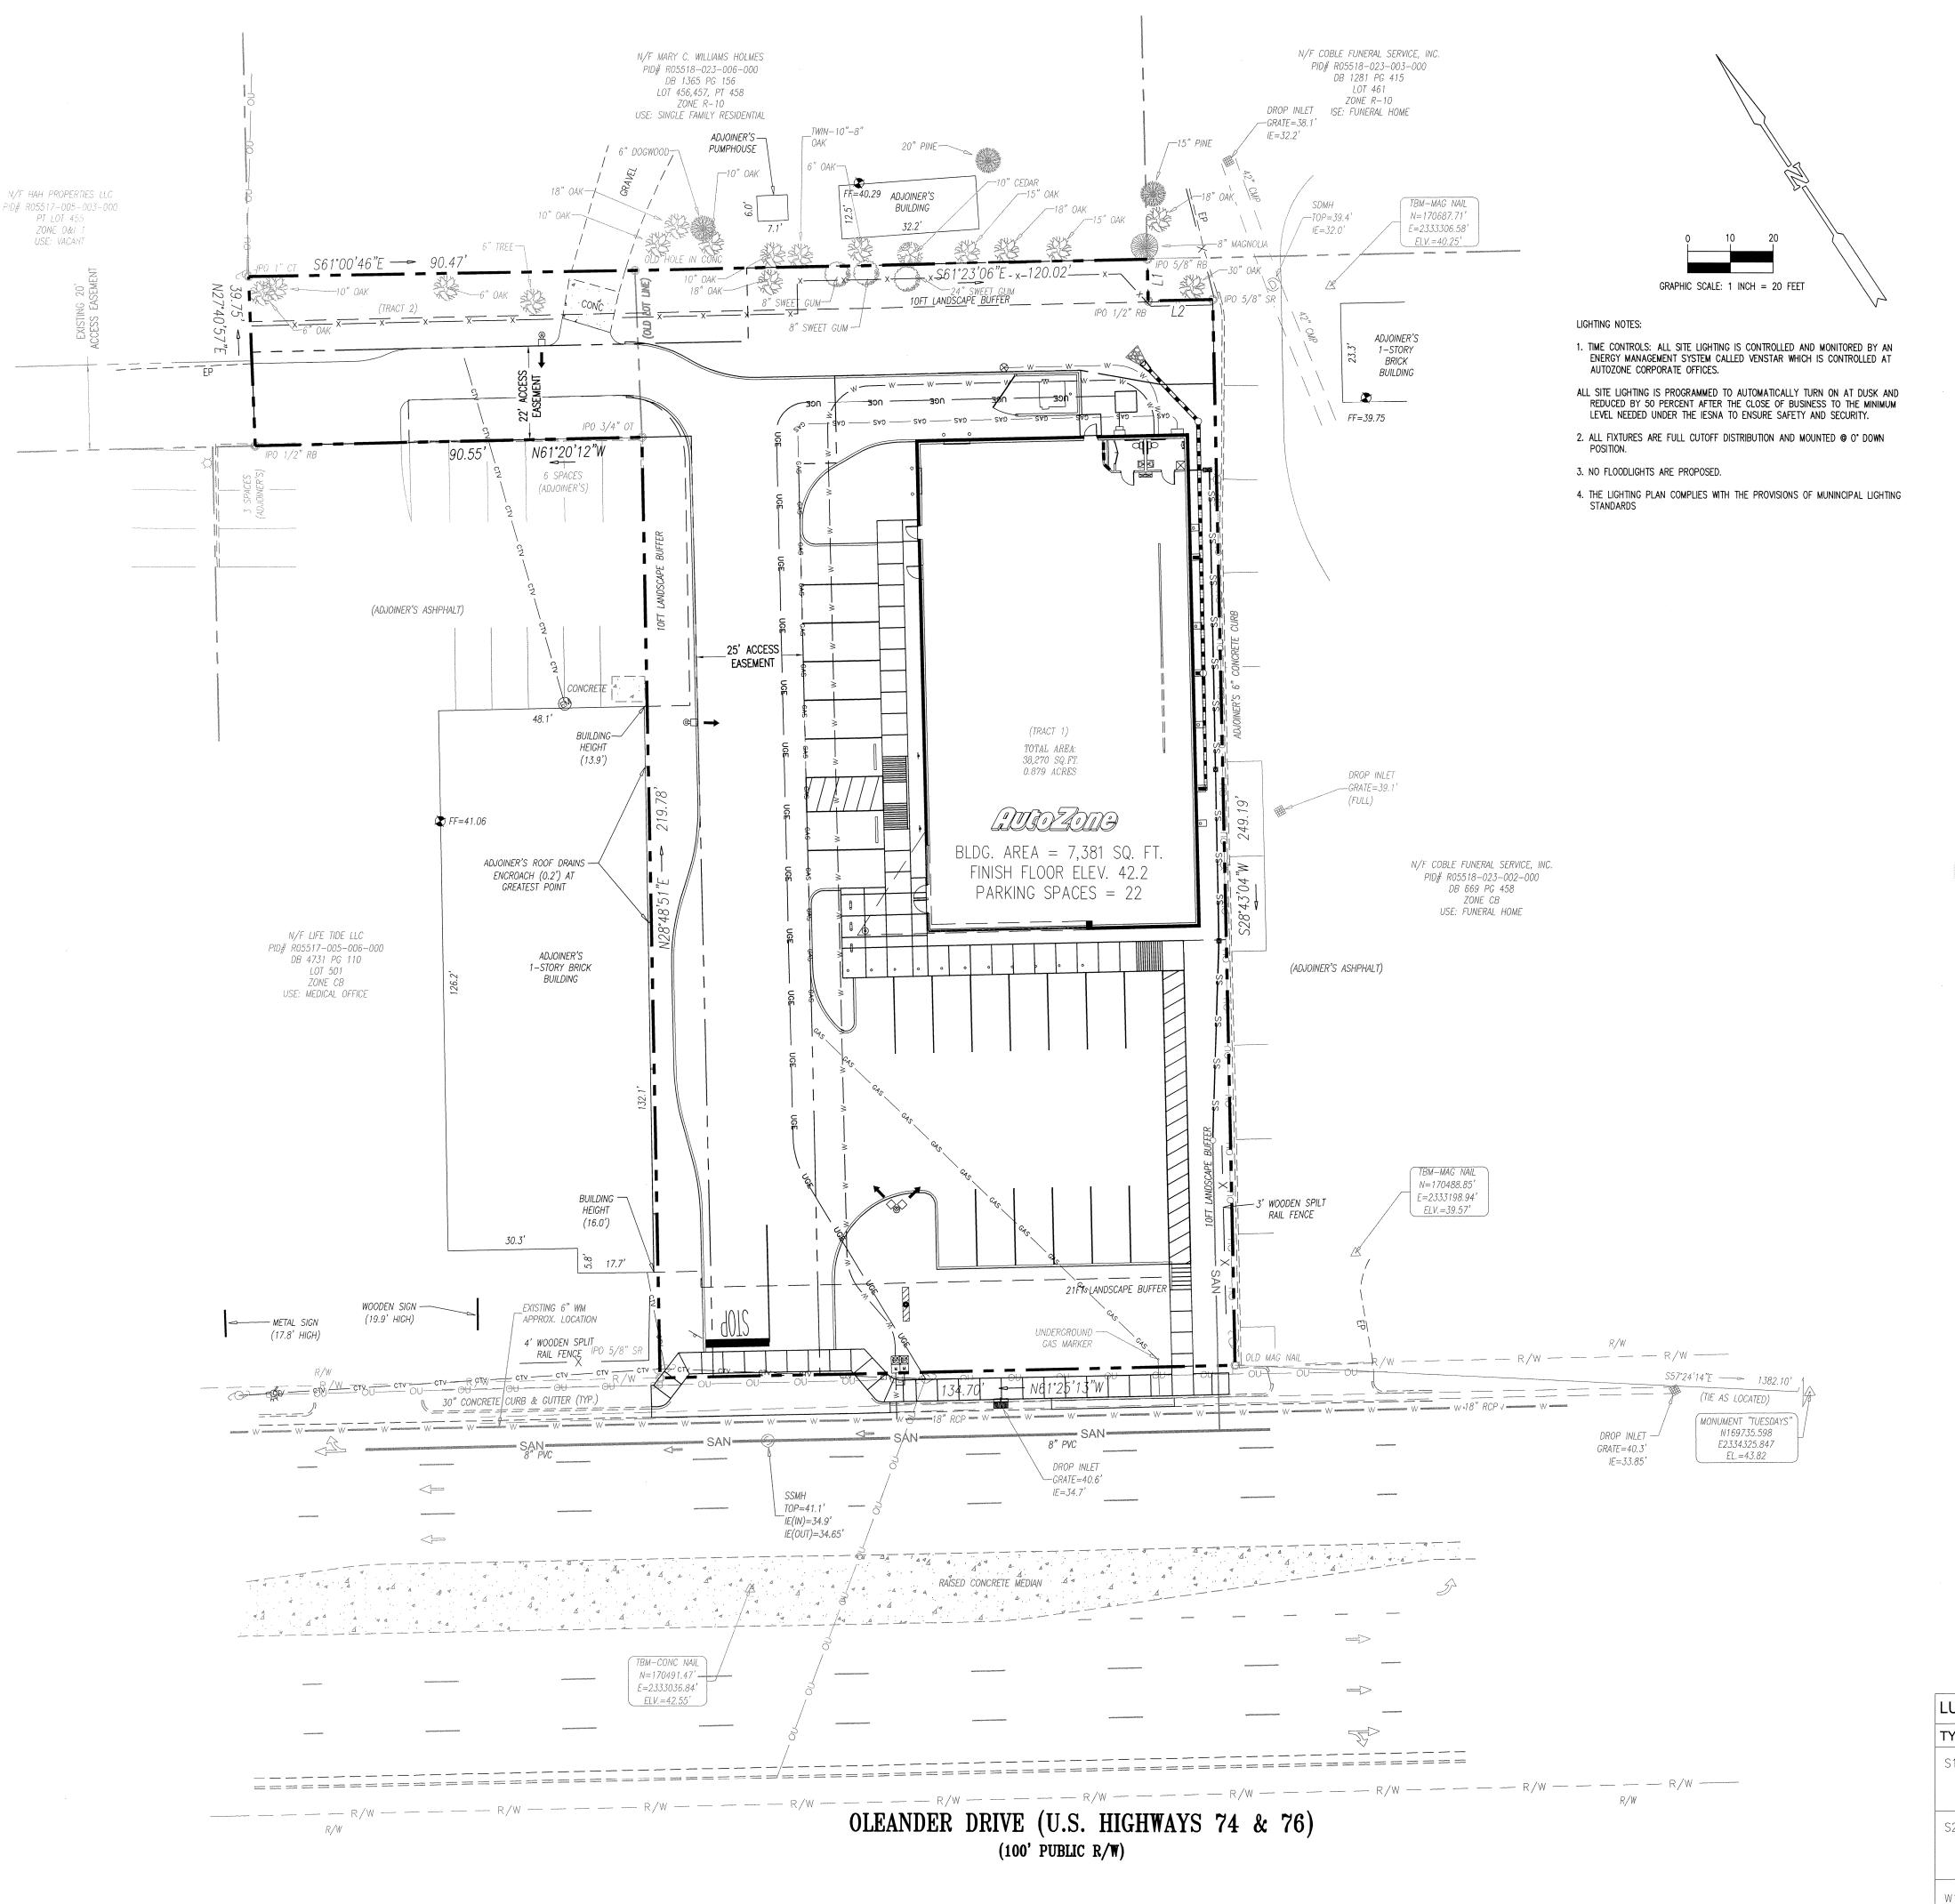
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REVISIONS:

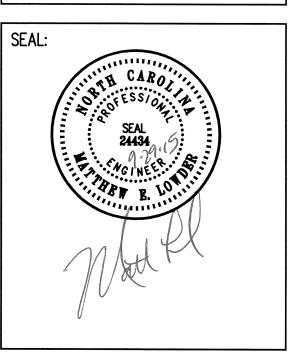LAYOUT COORD:	MEL
PLANNING MGR.	MEL
DRAWING BY:	MEL
DATE:	SEPTEMBER 29, 2015
JOB NUMBER:	010048
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DEMOLITION PLAN

SHEET NUMBER:





The modern styling of the D-Series is striking yet unobtrusive - making a bold, progressive statement even as it blends seamlessly with its


The D-Series distills the benefits of the latest in LED technology into a high performance, high efficacy, long-life luminaire. The outstanding photometric performance results in sites with excellent uniformity, greater pole spacing and lower power density. It is ideal for replacing 100 -400W metal halide in pedestrian and area lighting applications with typical energy savings of 65% and expected service life of over 100,000 hours.

Specifications

Width:

EXAMPLE: DSX1 LED 60C 1000 40K T3M MVOLT SPA DDBXD

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Consideration Consideratio	Series	LEDa		Drive	current		eraktær	Tistrii	ution	Voltage	Trans	ling	Contro	l options	Other	options.	Finish es	unci)
spire"	DSW LED	40C	(une engine) 40 LEDs towo enginesi 60 LEDs towo	700	760 mA 1600 mA	報度	TAND (TREE TOWN) SOUND (TREE TOWN) SOUND (TREE TOWN)	T2S T2M T3S T3M T4M TFTM T8VS	Type II short Type III short Type III short Type III short Type III short Type IV medium Type IV medium Type IV very short Type IV short Type IV medium	120° 208° 240° 277° 347	inclui SPM SPM	Square pole mount-ing Round pole mount-ing Wall	PER DMG DXR DX PRR PRR PRR PRR PRR PRR PRR PRR PRR PR	MEMA twist-lock receptacle only (no controls). On told dimmang driver indicated and controls). In matches and controls). Dimmatch and controls). Dimmatch and controls). Dual switching of mounting beight? Median sensor, 15–30° mounting beight? Switched dizenting, 30% 78 Switched dizenting, 30% 78	HS WIR S	House-side shield? Lintay terminal shock? Single Ruse (120, 277, 147V)?? Double Ruse (208, 140, 460V)?? Inol-less entry Hoger Lach Lest sortated optics? Right notated	DELED DMAXD DWHRD DOETAD DELEXD DMATAD	Natural aluminum White Rectured dark bronze Textured black Textured natural aluminum

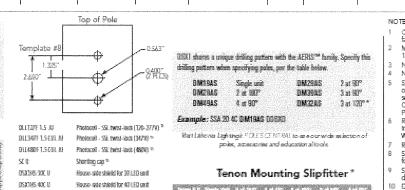

Configured with 4000K (40K) provides the shortest lead times. Consult factory for 3000K (30K) and 5000K (50K) lead times.
MVCUL driver operates on any line workings from 120-277V (50/60 Hz). Specify 120, 208, 240 or 277 options only when ordering with fusing (SF, DF options). Not available with single board, S30mA product (30C 530). Not available with 347 or 450%. rvices required for ROAMIB deployment, must be prechesed separately at 1-800-442-6745 or email: selectionams evides, not. Not available with minn.
Requires 40°C or 60°C. Provides 50°50 laminates operation via two
two two separate crouds. N/A with PER, CCR, DAKS or
WITE.

partities the Serece Switch SSR-10-ODF control see Motion Sensor C-in distalls. Dimining chiven standard. Not available with DOR or WTB. Specifies the SensorSwitch SER 6-00P control: see Motion Sensor Guide for datals. Dimming driver standard. Not available with DOR or WITE. Denoting driver standard, MMOLT only, Not available with DCR or WTB. Also available as a separate accessory, see Accessories information. WTB not available with BL30, BL50, DS, PIR or PIRH. Singlia fusa (SF) sequines 120, 277 or 347 voltage option. Double fuse (DF) requires 205, 240 or 480 voltage option. Available with 60 LEDs (60C option) only.

A LITHONIA LIGHTING.

RFM NAMACI (CORDI) U Bound pole DMT9 to RMTFWS adapter (specify betal)

One Lithonia Way + Conyers, Georgia 3001Z + Phone: 900.279.8041 + Fax: 770.918.1209 + www.lithonia © 2011-7013 Acuthy Brands Lighting, Inc., All rights reserved

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Luminaire

Height:

D-Series Size 1 LED Wall Luminaire

A DESIGNATION TO THE STATE OF T

Introduction The D-Series Wall luminaire is a stylish, fully

integrated LED solution for building-mount applications. It features a sleek, modern design Back Box (BBW, ELCW) and is carefully engineered to provide long-lasting,

energy-efficient lighting with a variety of optical and control options for customized performance. With an expected service life of over 20 years of nighttime use and up to 74% in energy savings over comparable 250W metal halide luminaires, the D-Series Wall is a reliable, low-maintenance lighting solution that produces sites that are

exceptionally illuminated.

Height:

EXAMPLE: DSXW1 LED 20C 1000 40K T3M MVOLT DDBTXD

Series	Perform	ance Parkage	Distrib	ution	Voitage:	Mounth	lig	Control	Opiews	Other Op	etions	Florish acqu	hrd;
DSXW1 LED	LEDs 10C 20C 0rive of 150 530 700 1000 Color N 40K 50K	10 LEDS (Ente engine) 20 LEDS (Iwo engines) Brown 250 mA 530 mA 700 mA 1000 mA 1000 mA 4000K	125 12M 135 13M 14M 161M	Type II Short Type III Short Type III Short Type III Medium Type IV Medium Forward Throw Medium	MWOLT: 120: 208: 240: 277:	1 ""	ed included Surface mounting backer Surface mounted back box for mount entry?	Shippe PE DMG PIR PIRH ELCW	d Installed Photoelectric cell, outlier type 1 0-10V distributing driver (no controls) 180° motion/ambient both sensor, 415° mily 18,15° 180° motion/ambient light sensor, 15-30° mily 18,15° triengency buttery backup (no distribution) ambient enclosure)?	SF DF HS	d Installed Single tase (120, 277V) 8 Double hase (208, 340V) 8 House-soile smeld 9 Bird-deserrent spakes 9 Wire quant 8 Vandal guard 9	DOBADD DBLXD DBLXD DBLXD DMAXD DWHEXD DSSXD DCGET XID CBLEND DMAT XD DSST XID	Dank brow Black Natural akumbrum Works Sandsabra Bertured browned Bertured b Bertured b Bertured sandsabra

MWCLT driver operates on any line voltage from 120-277V (SU/60 Hz). Specify 120, 208, 240 or 277 options only when ordering with fusing (SF, DF options), or pitotocontrol (PE options).
 Back box ships Installed on fixture. Cannot be field lestalled. Cannot be ordered as an accessory.

Photocontrol (PE) requires 120, 208, 240 or 277 voltage option. Not available with motion/arebient light. sessors (PSF or PRFI).

9 Also avaliable as a separate accessory, see Accessories information.

seasons give or PHHM.

4 Specifies the Serson Switch SSR-10-CDP control see Motion Season Guide for details. Includes ambient light season Not available with "PE" option (button type photocell). Dimming driver standard.

5 Specifies the Season Switch SSR-6-CDP control see Motion Season Guide for details, Includes ambient light season. Not available with "PE" option (button type photocell). Dimming driver standard.

6 Not available with 20 LED/1000 mA coefigeration (DSANY) LED 20C 1000). Not compatible with conduit entry applications. Not available with 25% mounting option. 8 Single has (SF) requires 120 or 277 voltage option. Coeble has (CF) requires 208 or 240 voltage option.

Ordered and shipped separately. DODWES II House-side shield (one per light engine) DSTWICTM U Bird-determed spiles Management of the production of the contract o CONTROL F Vanial grand account

Accessories


LITHONIA LIGHTING

One Lithonia Way . Conyers, Georgia 30012 . Phone: 200,279 2041 . Fax: 770 918.1209 . www.lithonia.com © 2013 Acuthy Brands Lighting, Inc., All rights reserved.

LUM	IINAIRE SO	CHEDULE				
TYP	SYMBOL	DESCRIPTION	LAMP	LUMENS	LLF	QTY
S1	Œ]	LITHONIA - DSX1 LED 60C IES FULL CUTOFF DISTRIBUTION MOUNTED 0° DOWN POSITION MOUNTED HEIGHT = 28'-0"	LED — 209 WATTS	ABSOLUTE	0.95	2
S2		LITHONIA - DSX1 LED 60C IES FULL CUTOFF DISTRIBUTION MOUNTED 0° DOWN POSITION MOUNTED HEIGHT = 28'-0"	LED - 418 WATTS	ABSOLUTE	0.95	1
W1	\Box	LITHONIA - DSW1 LED 10C IESNA FULL CUTOFF DISTRIBUTION MOUNTED 0° DOWN POSITION MOUNTED HEIGHT = 12'-0"	LED - 40 WATTS	ABSOLUTE	0.95	



CONSULTANT: TRIANGLE SITE DESIGN, PLLC 4006 BARRETT DR, STE 203 RALEIGH, NC 27609 (919) 553-6570 LICENSE #P-0619

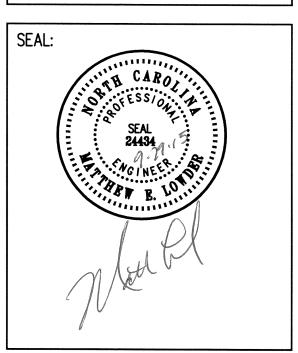

6486 STOR 3913 (US F

OWNER/DEVELOPER: AUTOZONE DEVELOPMENT, LLC ATTN. WADE DAVIS 123 S. FRONT STREET 3RD FLOOR MEMPHIS, TN 38103-2107 PHONE: (901) 495-8701 FAX: (901) 495-8969 wade.davis@autozone.com For Bidding & Contractor Information Contact:

F.W. Dodge Plan Room Tel: (615) 884-1017

REVISIONS:

LAYOUT COORD:	MEL
PLANNING MGR.	MEL
DRAWING BY:	MEL
DATE:	SEPTEMBER 29, 2015
JOB NUMBER:	010048

LIGHTING PLAN

SHEET NUMBER:

<u>DATA</u> ZONED: CB - COMMUNITY BUSINESS SETBACK REQUIREMENTS: FRONT - 20 FEET

MAXIMUM BUILDING HEIGHT: 45 FEET

MAXIMUM NUMBER OF STORIES: 3

MINIMUM LOT SIZE: 1/2 ACRES

AUTOZONE IS A PERMITTED USE FOR THIS ZONING DISTRICT.

SOURCE OF DATA

CITY OF WILMINGTON, N.C.

ACCESS NOTE

ACCESS TO SUBJECT PROPERTY VIA PUBLIC

RIGHT-OF-WAY OF OLEANDER DRIVE

municode.com

MINIMUM LOT WIDTH: 80'

SIDE - O FEET

REAR - 10 FEET

38,270 SQ.FT. 0.879 ACRES

PARKING REQUIREMENTS

REQUIRED NUMBER

N/A

OF SPACES

GROSS FLOOR AREA OF

ESTABLISHMENT IN S.F.

LESS THAN 5,000

5,000 TO 24,499

25,000 TO 49,999

50,000 TO 99,000

100,000

TOTAL AREA

ACCORDING TO THE FEDERAL EMERGENCY MANAGEMENT AGENCY'S FLOOD INSURANCE RATE MAP, NEW HANOVER COUNTY, NORTH CAROLINA, WITH AN EFFECTIVE DATE OF APRIL 3, 2006, THE PROPERTY SURVEYED AND SHOWN HEREON LIES WITHIN ZONE "X" PER COMMUNITY MAP NO. 3720313700J. CITY OF WILMINGTON, NORTH CAROLINA NUMBER 370171

REFERENCE PLAT

TAX ASSESSOR PARCEL NO.

R05518-023-001-000

PLAT ENTITLED "ALTA/ACSM LAND TITLE SURVEY FOR MB ONE CAPITAL, LLC, PREPARED BY PATRICK C. BRISTOW LAND SURVEYING,

PC, DATED OCTOBER 9, 2013

FLOOD ZONE

NORTH CAROLINA STATE PLANE COORDINATES WERE USED AS THE BASIS OF BEARINGS FOR THIS SURVEY.

BASIS OF BEARINGS

ENCROACHMENTS/PROJECTIONS

(A) ADJOINER'S CONCRETE CURB ENCROACHES 0.5'

TITLE LEGAL DESCRIPTION

1. NORTH CAROLINA STATE PLANE COORDINATES WERE USED AS THE BASIS OF BEARINGS FOR THIS SURVEY. 2. SUBJECT PROPERTY APPEARS TO DRAIN INTO A PUBLIC RIGHT OF WAY,

MISCELLANEOUS NOTES:

UNLESS OTHERWISE SHOWN OR NOTED.

3. THERE IS OBSERVABLE EVIDENCE OF EARTH MOVING WORK, BUILDING CONSTRUCTION OF BUILDING ADDITIONS WITHIN RECENT MONTHS ON SUBJECT

4. REFERENCE DEED: DB 5557 PG 0465

5. THERE ARE NO KNOWN CHANGES IN STREET RIGHT OF WAY LINES, EITHER COMPLETED OR PROPOSED, AND AVAILABLE FROM THE CONTROLLING JURISDICTION.

6. THERE IS OBSERVABLE EVIDENCE OF RECENT STREET OR SIDEWALK CONSTRUCTION OR REPAIRS.

7. THERE IS NO OBSERVABLE EVIDENCE OF SITE USE AS A SOLID WASTE DUMP, SUMP OR SANITARY LAND FILL

8. THERE IS NO OBSERVED EVIDENCE OF THE LOCATION OF CEMETERIES AND BURIAL GROUNDS.

9. MAP PIN: R05518-023-001-000

10. ALL DRIVES/PARKING LOTS ARE ASPHALT PAVING UNLESS OTHERWISE NOTED

11. CURRENT OWNER OF RECORD: INDEPENDENCE GENE LLC

12. DIRECT ACCESS TO SUBJECT PROPERTY VIA PUBLIC RIGHT OF WAY OF OLEANDER DRIVE

13. STREET ADDRESS NOT POSTED AT TIME OF FIELD SURVEY.

14. RECORD DESCRIPTION AS PROVIDED DOES FORM A MATHEMATICALLY CLOSED

15. OBSERVED UTILITIES EITHER ENTER SUBJECT PROPERTY FROM PUBLIC RIGHT OF WAY OR THROUGH DEDICATED EASEMENTS, UNLESS OTHERWISE NOTED HEREON

16. BY OBSERVED EVIDENCE ONLY, THE SUBJECT PROPERTY DOES SERVE ADJOINING PROPERTY FOR UTILITIES, DRAINAGE, STRUCTURAL SUPPORT OR INGRESS OR EGRESS

17. NO EVIDENCE OF POTENTIAL WETLANDS WERE OBSERVED ON THE SUBJECT PROPERTY AT THE TIME THE SURVEY WAS CONDUCTED, NOR HAVE WE RECEIVED ANY DOCUMENTATION OF ANY WETLANDS BEING LOCATED ON THE SUBJECT




SURVEYORS CERTIFICATE

TO:

THIS IS TO CERTIFY THAT THIS MAP OR PLAT AND THE SURVEY ON WHICH IT IS BASED WERE MADE IN ACCORDANCE WITH THE 2011 MINIMUM STANDARD DETAIL REQUIREMENTS FOR ALTA/ACSM LAND TITLE SURVEYS, JOINTLY ESTABLISHED AND ADOPTED BY ALTA AND NSPS, AND INCLUDES ITEMS 1, 2, 3, 4, 5, 6(B), 7(A), 7(B)(1), 7(C), 8, 9, 10(A), 11(A), 13, 14, 16, 17, 18 AND 21 OF TABLE A THEREOF. THE FIELD WORK WAS COMPLETED ON JANUARY 20, 2015

DATE OF PLAT OR MAP: 1-23-15

BY: T.A. SHERARD, P.L.S.

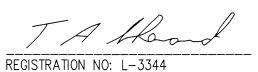

STATE OF NORTH CAROLINA



THE PROPERTY DESCRIBED AND SHOWN HEREON IS THE SAME PROPERTY DESCRIBED IN [INSERT NAME OF TITLE COMPANY] TITLE COMMITMENT NO. _____ DATED _____, 201__.

BL BUILDING LINE CL CENTERLINE CMP CORRUGATED METAL PIPE CT CRIMP TOP DE DRAINAGE EASEMENT EP EDGE OF PAVEMENT IPO IRON PIN OLD-O IPS IRON PIN SET-O N&C NAIL & CAP OT OPEN TOP RB REBAR RCP REINFORCED CONC PIPE R/W RIGHT OF WAY

SD STORM DRAIN SS SANITARY SEWER

SSE SS EASEMENT

■ B-1 SOIL BORING

TEL 🖸 TELEPHONE PEDESTAL EM ELECTRIC METER CB ☐ CATCH BASIN DI I DROP INLET ☑ ELEC TRANS ×90.0 ELEVATION FIRE HYDRANT ⊕ GAS METER GV ⋈ GAS VALVE LP \$\pi LIGHT POLE

PP DPOWER POLE

GP - GUY ANCHOR

SDMH D SD MANHOLE

SSMH S SS MANHOLE

CO • CLEAN OUT

TMH T TELEPHONE MANHOLE

WV∭WATER VALVE ---CTV--- CABLE TV ---X--- FENCE LINE ---FOC--- FIBER OPTIC CABLE ----GAS--- GAS LINE ----OHP--- OVERHEAD POWER ----OHT--- OVERHEAD TELEPHONE ----SD--- STORM DRAIN ----SS--- SANITARY SEWER

ACJ/DRA

-----W----- WATER LINE

CATV CABLE TV PEDESTAL

VCP VITRIFIED CLAY PIPE

WMWATER METER

TC/BC TOP/BOTTOM CURB

TW/BW TOP/BOTTOM WALL

SHEET 1 OF 2

"ALTA / ACSM LAND TITLE SURVEY"

AUTO ZONE

3913 OLEANDER DRIVE NEW HANOVER COUNTY WILMINGTON, NORTH CAROLINA

BM/JA 1/22/2015 1"=20'

CIVIL ENGINEERS - SURVEYORS - LANDSCAPE ARCHITECTS

800 E. WASHINGTON ST, STE. B GREENVILLE, SC 29601 PH: (864)271-0496 FAX: (864)271-0402 www.sitedesign-inc.com

GRAPHIC SCALE

(IN FEET)

1 inch = 20 ft.

NOT FOR CONSTRUCTION

PRELIMINARY

DESIGN, INC.

No. C00122

